

Addendum No. 3

To: Planholder Bidders

From: Shannon McIntyre

City of Mobile Architectural Engineering Department

Re: Crawford-Murphy Park – New Splashpad

Project #PR-006-25

and

Crawford-Murphy Park – Parking Lot and Lighting Improvements

Project #PR-007-23

Date: May 27, 2025

This Addendum forms a part of, and modifies, the Request for Bids, for the above referenced project, dated May 14, 2025. Acknowledge the receipt of this Addendum No. 3 in the space provided on the Bid Form. Failure to do so may subject Bidder to disqualification.

General:

Request for Bids:

Drawings:

Item 1. Drawings attached shall be used in lieu of drawings issued May 14, 2025.

RFI's:

N/A

END OF ADDENDUM NO. 3

A Landscape Development Plan for

Crawford-Murphy Park: Splash Pad, Parking Lot & Lighting

PR-006-25; PR-007-23 Mobile, Alabama

Prepared for
City of Mobile
Mobile, Alabama

Prepared by

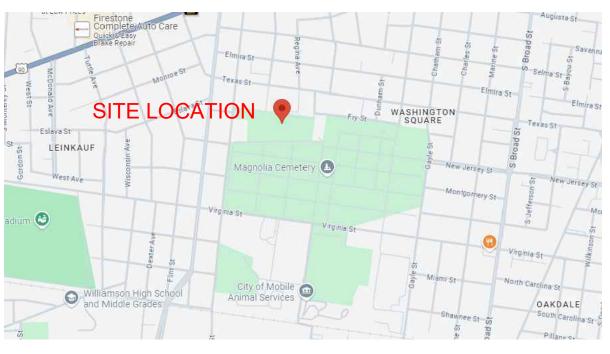


PROJECT SUMMARY

THE PROJECT DESCRIBED ON THIS DRAWING IS A LANDSCAPE DEVELOPMENT PROJECT THAT COVERS WORK DESCRIBED AS:

- DEMOLITION: WADE POOL, CONCRETE & ASPHALT PAVING,
- EXISTING BOLLARDS AND GATES
 GRADING: GRADING & DRAINAGE IMPROVEMENTS
- SITE: PARKING LOT IMPROVEMENTS, DOG PARK & PARKING LOT SECURITY LIGHTING, SPLASH PAD INSTALLATION, HARDSCAPE
- IMPROVEMENTSLANDSCAPE: ENHANCED PLANTING PLAN

WORK WILL BE COMPETITIVELY BID WITH THE OWNER DETERMINING THE WINNING SUBCONTRACTOR AT THEIR SOLE DISCRETION. THE CONTRACT AMOUNT SHALL BE BASED UPON A STIPULATED SUM THAT IS INDICATED ON THE PROJECT'S BID FORM. THE WORK AGREEMENT SHALL BE BETWEEN THE SELECTED CONTRACTOR AND THE PROJECT OWNER. THE OWNER HAS RETAINED THE SERVICES OF WAS DESIGN, INC. TO ASSIST IN CONSTRUCTION OBSERVATION AND CONTRACT ADMINISTRATION.



SITE LOCATION MAP

	Sheet List Table
heet Number	Sheet Title
CS100	COVER SHEET
EC100	EXISTING CONDITIONS
ER100	EROSION CONTROL PLAN
ER500	EROSION CONTROL DETAILS
DP100	DEMOLITION PLAN)
DP200	DEMOLITION ENLARGEMENT
DP201	DEMOLITION ENLARGEMENT
DP202	DEMOLITION ENLARGEMENT
SP100	SITE PLAN
LG100	LANDSCAPE GRADING PLAN
LG200	GRADING ENLARGEMENT
LG201	GRADING ENLARGEMENT
LG202	GRADING ENLARGEMENT
LG4 <u>0</u> 0	GRADING PROFILES
LH100	HARDSCAPE PLAN
_LH200	HARDSCAPE ENLARGEMENT
LH201	HARDSCACE ENLARGEMENT
LH202	HARDSCAPE ENLARGEMENT
LH500	HARDSCAPE DETAILS
LH501	HARDSCAPE DETAILS
LH502	HARDSCAPE DETAILS
LH503	HARDSCAPE DETAILS
LH504	HARDSCAPE DETAILS
LH505	HARDSCAPE DETAILS
LH506	HARDSCAPE DETAILS
LH507	HARDSCAPE DETAILS
LH508	HARDSCAPE DETAILS
LH509	HARDSCAPE DETAILS
LH510	HARDSCAPE DETAILS
LP100	LANDSCAPE PLANTING PLAN
LP200	PLANTING ENLARGEMENT
LP201	PLANTING ENLARGEMENT
LP500	PLANTING DETAILS
AQ500	AQUATIC ISOMETRIC PLAN
AQ501	AQUATIC ISOMETRIC PLAN
AQ502	AQUATIC LAYOUT PLAN
AQ503	AQUATIC PLUMBING PLAN
AQ504	AQUATIC DRAINAGE PLAN
AQ505	AQUATIC ELECTRIC PLAN
AQ506	AQUATIC DETAILS
AQ507	AQUATIC CABINET
E100	ELECTRICAL LEGEND AND SPECIFICATIONS
ÉP200	EXISTING OVERALL ELECTRICAL PLAN (BASE BID)
EP300	MODIFIED OVERALL ELECTRICAL PLAN (BASE BID)
EP400	SPLASHPAD - ENLARGED ELECTRICAL PLAN (BASE BID)
EP500	ELECTRICAL DETAILS AND SCHEDULES (BASE BID)
EL200	EXISTING OVERALL LIGHTING PLAN (ADD ALTERNATE 1)
EL300	MODIFIED OVERALL LIGHTING PLAN (ADD ALTERNATE 1)
EL400	SITE PHOTOMETRIC PLAN (ADD ALTERNATE 1)
EL500	ELECTRICAL DETAILS AND SCHEDULES (ADD ALTERNATE 1)
P100	SPLASHPAD - PLUMBING PLAN

800-292-8525 #DIG (Cellular)	Mahama € Call
Dig Safely.	<u>Alabama</u> E Call

GENERAL NOTES

<u>SE DATA NOTES</u>

BASE PLAN DATA IS BASED ON THE BEST AVAILABLE AND PROVIDED DATA. MINOR FIELD ADJUSTMENTS ARE EXPECTED. MAJOR FIELD ADJUSTMENTS SHOULD BE APPROVED BY THE OWNER'S

CONSTRUCTION NO

- I. CONSTRUCTION STAKE—OUT IS THE RESPONSIBILITY OF THE CONTRACTOR. ELEMENTS ARE TO BE STAKED IN THE FIELD BY THE CONTRACTOR FOR REVIEW AND APPROVAL OF THE OWNER'S REPRESENTATIVE PRIOR TO COMMENCEMENT OF CONSTRUCTION. ANY CONFLICTS IN FIELD THAT MAY ARISE, CONTRACTOR IS TO MAKE BEST JUDGEMENT DURING FIELD STAKE—OUT & COORDINATE WITH OWNER'S REPRESENTATIVE/L.A. FOR APPROVAL.
- ALL HARDSCAPE MATERIALS & COLORS ARE TO BE APPROVED BY OWNER.
 CONTRACTOR SHALL VERIFY THE LOCATIONS OF ALL UTILITIES PRIOR TO CONSTRUCTION. EXISTING UTILITIES TO REMAIN SHALL BE
- PROTECTED FROM CONSTRUCTION ACTIVITIES.

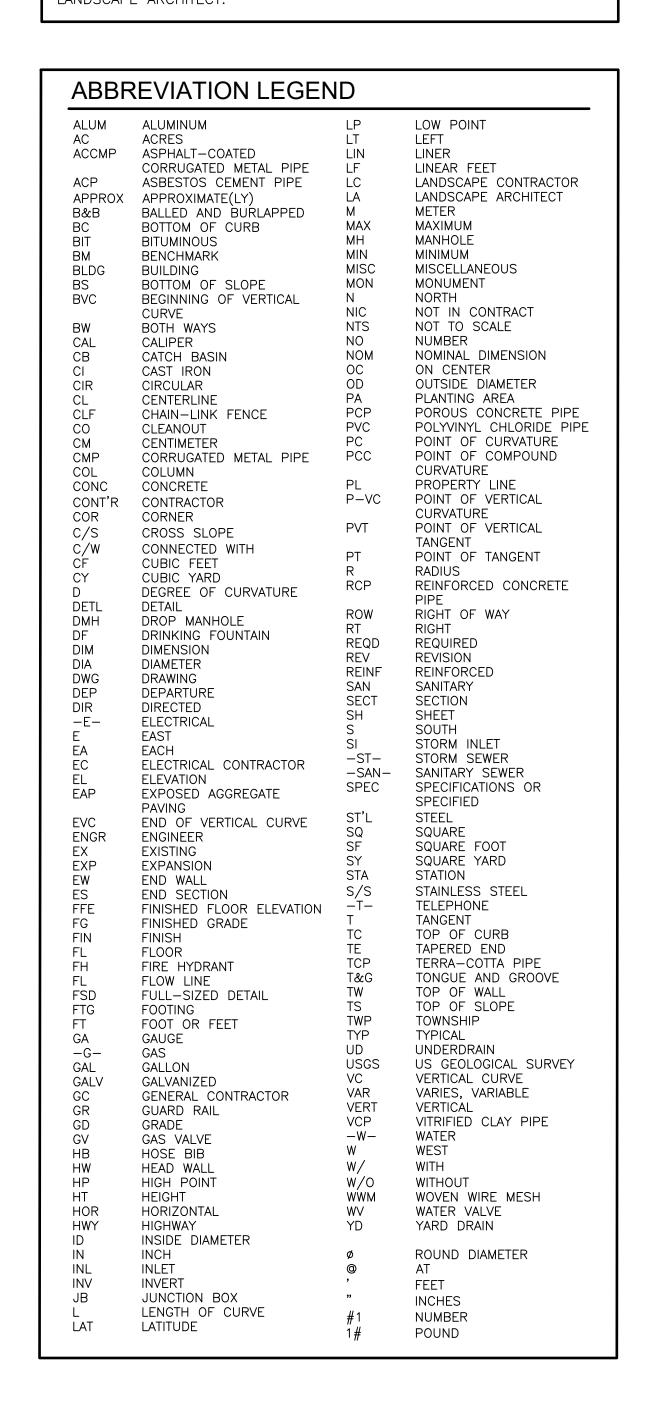
 4. CONTRACTOR SHALL STAGE CONSTRUCTION ACTIVITY IN SUCH A MANNER AS TO MINIMIZE THE AREA OF DISTURBED EARTH AT THE END OF EACH WORK DAY.

DISTURBED AREAS

AREAS DISTURBED BY CONSTRUCTION ACTIVITIES SHALL RECEIVE SOD OR MULCH AS NECESSARY AND SHOULD BE RETURNED TO 'BETTER THAN WHEN THE WORK STARTED' CONDITION.

NITITY TAKEOFE DISCLAIMER

QUANTITIES NOTED ON PLANS ARE OFFERED AS A CONVENIENCE TO THE CONTRACTOR FOR BID PURPOSES ONLY. CONTRACTOR SHALL VERIFY ALL QUANTITIES AND REPORT ANY DISCREPANCIES TO THE LANDSCAPE ARCHITECT.





A Landscape Development Plan for Crawford-Murphy Park: Splash Pad, Parking Lot & Lichting

No.	Date	Revisions / Submissions
	05.07.25	100% BID DRAWINGS
	05.16.25	ADDENDUM 1

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(WP	Registration
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)CT	JAMES JAMES
Project Manager	JAMES
IEC	CROWE?
Principal	\\\\\\\\\\\\\\\\\\\\\\\\\\\\\\\\\\\\\\
246010-032	SWALL BOWNERS ()
Project No.	
02.13.25	LANDSCAPE AND

Sheet Title

COVER SHEET

Sheet No.

CS100

GENERAL NOTES

ANY OTHER CONSTRUCTION RELATED ACTIVITIES.

CONTRACTOR TO COORDINATE ALL WORK AS REQUIRED WITH THE UTILITY COMPANY AND SHALL INCLUDE ALL REQUIRED ASSOCIATED FEES IN THE BASE BID.

ALL DISTURBED AREAS NOT NOTED AS TO BE SODDED SHALL BE SODDED W/CENTIPEDE SOD. THE CONTRACTOR SHALL BE RESPONSIBLE FOR IMPLEMENTING AND MAINTAINING ANY AND ALL NECESSARY ENVIRONMENTAL CONTROL MEASURES IN ACCORDANCE WITH ALL LOCAL, STATE, AND FEDERAL LAWS AND REQUIREMENTS. THIS INCLUDES PROTECTION FROM CONCRETE SURFACE PREPARATIONS, EROSION AND SEDIMENT CONTROLS, AS WELL AS A RESULT FROM

THE CONTRACTOR SHALL PROVIDE, INSTALL, AND MAINTAIN ALL TEMPORARY EROSION CONTROL MEASURES SHOWN ON THE DRAWINGS. WATTLES, HAY BALES, SILT FENCES AND OTHER APPROVED EROSION CONTROL DEVICES SHALL BE INSTALLED BY THE CONTRACTOR AND SHALL BE MAINTAINED THROUGHOUT THE COURSE OF THIS PROJECT. ADJUSTMENTS TO THE METHODS AND TYPES OF EROSION CONTROL WILL BE NECESSARY DURING THE CONSTRUCTION. AND IT WILL BE THE RESPONSIBILITY OF THE CONTRACTOR TO PROVIDE, INSTALL AND MAINTAIN THESE AS WELL. THE ARCHITECT SHALL APPROVE METHODS OF EROSION CONTROL. IT WILL BE THE RESPONSIBILITY OF THE CONTRACTOR TO SATISFY THEMSELVES THAT ALL FEDERAL, STATE AND LOCAL CODES AND ORDINANCES ARE ABIDED BY AT ALL TIMES DURING CONSTRUCTION. ADDITIONALLY, THE CONTRACTOR SHALL IMPLEMENT ANY AND ALL OTHER BEST MANAGEMENT PRACTICES APPLICABLE PER FEDERAL, STATE, COUNTY AND MUNICIPAL LAWS CONCERNING

THE CONTRACTOR SHALL BE RESPONSIBLE FOR IMPLEMENTING ALL EROSION CONTROL BMPS AND FOR ALL SEDIMENT WITHIN AND LEAVING THE CONSTRUCTION SITE UNTIL THE PROJECT IS ACCEPTED BY THE ARCHITECT. SEVERE PENALTIES MAY BE IMPOSED TO ENSURE COMPLIANCE.

ALL PROJECTS AND CONSTRUCTION SITES SHALL BE IN ACCORDANCE WITH THE CLEAN WATER ACT; THE ALABAMA WATER POLLUTION CONTROL ACT; THE CURRENT VERSION OF THE ALABAMA HANDBOOK FOR EROSION CONTROL, SEDIMENT CONTROL AND STORMWATER MANAGEMENT ON CONSTRUCTION SITES AND URBAN AREAS.

ANY FINES, PENALTIES, OR JUDGMENTS ACCESSED TO THE CITY OF MOBILE, ITS AGENTS OR REPRESENTATIVES DUE TO INADEQUATELY INSTALLED OR MAINTAINED EROSION CONTROL SHALL BE THE RESPONSIBILITY OF THE CONTRACTOR. THE CONTRACTOR SHALL INDEMNIFY AND HOLD HARMLESS THE ARCHITECT, ENGINEER, CITY OF MOBILE, ITS AGENTS, OR REPRESENTATIVES FROM ALL CLAIMS RESULTING, ALL OR IN PART, FROM INADEQUATELY INSTALLED OR MAINTAINED EROSION CONTROLS.

NOTE:

WATER POLLUTION.

ALL INLETS TO RECEIVE SAND BAGS AS

NOTE:

REFER TO ER500 FOR WATTLE AND SAND BAG DETAILS

SOIL EROSION AND SEDIMENT NOTES:

- . SOILS MUST BE STABILIZED BY TEMPORARY OR PERMANENT EROSION CONTROL WITHIN FOURTEEN (14) DAYS AFTER CLEARING OR INACTIVITY IN CONSTRUCTION. 1.1. IF VEGETATIVE EROSION CONTROL METHODS, SUCH AS SEEDING, HAVE NOT BECOME ESTABLISHED WITHIN FOUR (4) WEEKS OF PLANTING OR INSTALLATION, THE CITY OF MOBILE MAY REQUIRE THAT THE SITE BE RESEEDED, SOLID SODDED, OR THAT A NON-VEGETATIVE OPTION BE
- TEMPORARILY EMPLOYED. 2. TECHNIQUES SHALL BE EMPLOYED TO PREVENT THE BLOWING OF DISTURBED SOILS OR SEDIMENT FROM THE SITE ON TO ADJACENT PROPERTIES.
- 3. ALL DRAINAGE SWALES MUST BE GRASSED AS REQUIRED TO CONTROL EROSION.
- 4. SILT FENCE MUST BE IN ACCORDANCE WITH
- DETAILS AS SHOWN ON THESE PLANS. 5. ALL DISTURBED AREAS TO BE GRASSED AS SOON
- AS CONSTRUCTION PHASES ARE COMPLETE. 6. ALL EROSION CONTROL MEASURES SHALL BE IN PLACE PRIOR TO COMMENCING CONSTRUCTION AND

SHALL BE MAINTAINED IN PROPER WORKING ORDER

SIDE OF ALL PROPOSED FILL CONSTRUCTION. 8. CONTRACTOR SHALL MAINTAIN ALL EROSION CONTROL MEASURES UNTIL PERMANENT VEGETATION HAS BEEN ESTABLISHED. CONTRACTOR SHALL INSPECT EROSION CONTROL MEASURES AT

UNTIL ALL DISTURBED AREAS ARE STABILIZED. CONSTRUCTION ENTRANCE PADS SHALL BE

ACCESS POINTS PRIOR TO LAND DISTURBANCE.

7. CONSTRUCT SILT FENCE ALONG THE DOWNSTREAM

INSTALLED BY THE CONTRACTOR AT CONSTRUCTION

- THE END OF EACH WORKING DAY TO ENSURE MEASURES ARE FUNCTIONING PROPERLY. 9. THE CONTRACTOR SHALL REMOVE ACCUMULATED
- THE SILT FENCE UTILIZED FOR EROSION CONTROL. 10. THE CONTRACTOR SHALL SIZE, INSTALL, AND MAINTAIN ADEQUATE CONTROLS FOR THE SITE. REFER TO "THE ALABAMA HANDBOOK FOR EROSION CONTROL, SEDIMENT CONTROL, & STORMWATER MANAGEMENT ON CONSTRUCTION SITES & URBAN AREAS," LATEST EDITION.

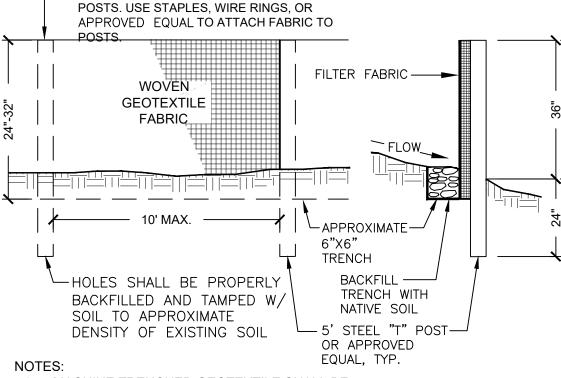
SILT WHEN THE SILT IS WITHIN 12" OF THE TOP OF

TYPE 'A' SILT FENCE NOTES:

- 1. SILT FENCES ARE TEMPORARY EROSION CONTROL ITEMS THAT SHALL BE ERECTED OPPOSITE ERODIBLE AREAS
- 2. SILT FENCE SHOULD BE PLACED WELL INSIDE PROPERTY BOUNDARY, R.O.W. AND/OR ALONG EDGE OF CLEARING LIMITS. THIS WILL ALLOW ROOM FOR A BACK-UP FENCE IF FIRST BECOMES FULL.
- 3. SILT FENCES SHALL BE IN PLACE PRIOR TO ANY CONSTRUCTION OPERATION.

SUCH AS NEWLY GRADED FILL SLOPES AND ADJACENT TO STREAMS AND CHANNELS.

- 4. WHEREVER POSSIBLE, SILT FENCES SHALL BE CONSTRUCTED ACROSS A FLAT AREA IN THE SHAPE OF A HORSESHOE. THIS AIDS IN PONDING OF RUNOFF AND FACILITATES SEDIMENTATION.
- 5. AFTER THE CONSTRUCTION AREA IS STABILIZED AND EROSION ACTIVITY CURTAILED, SILT FENCES SHALL BE
- REMOVED. 6. RING FASTENERS USED TO SECURE GEOTEXTILES TO WOVEN WIRE SHALL BE 13 GA. (AMERICAN).
- 7. TOP AND BOTTOM LINE WIRES SHALL BE 10 GAUGE. INTERMEDIATE WOVEN WIRE TO BE 12 1/2 GAUGE (MIN.).

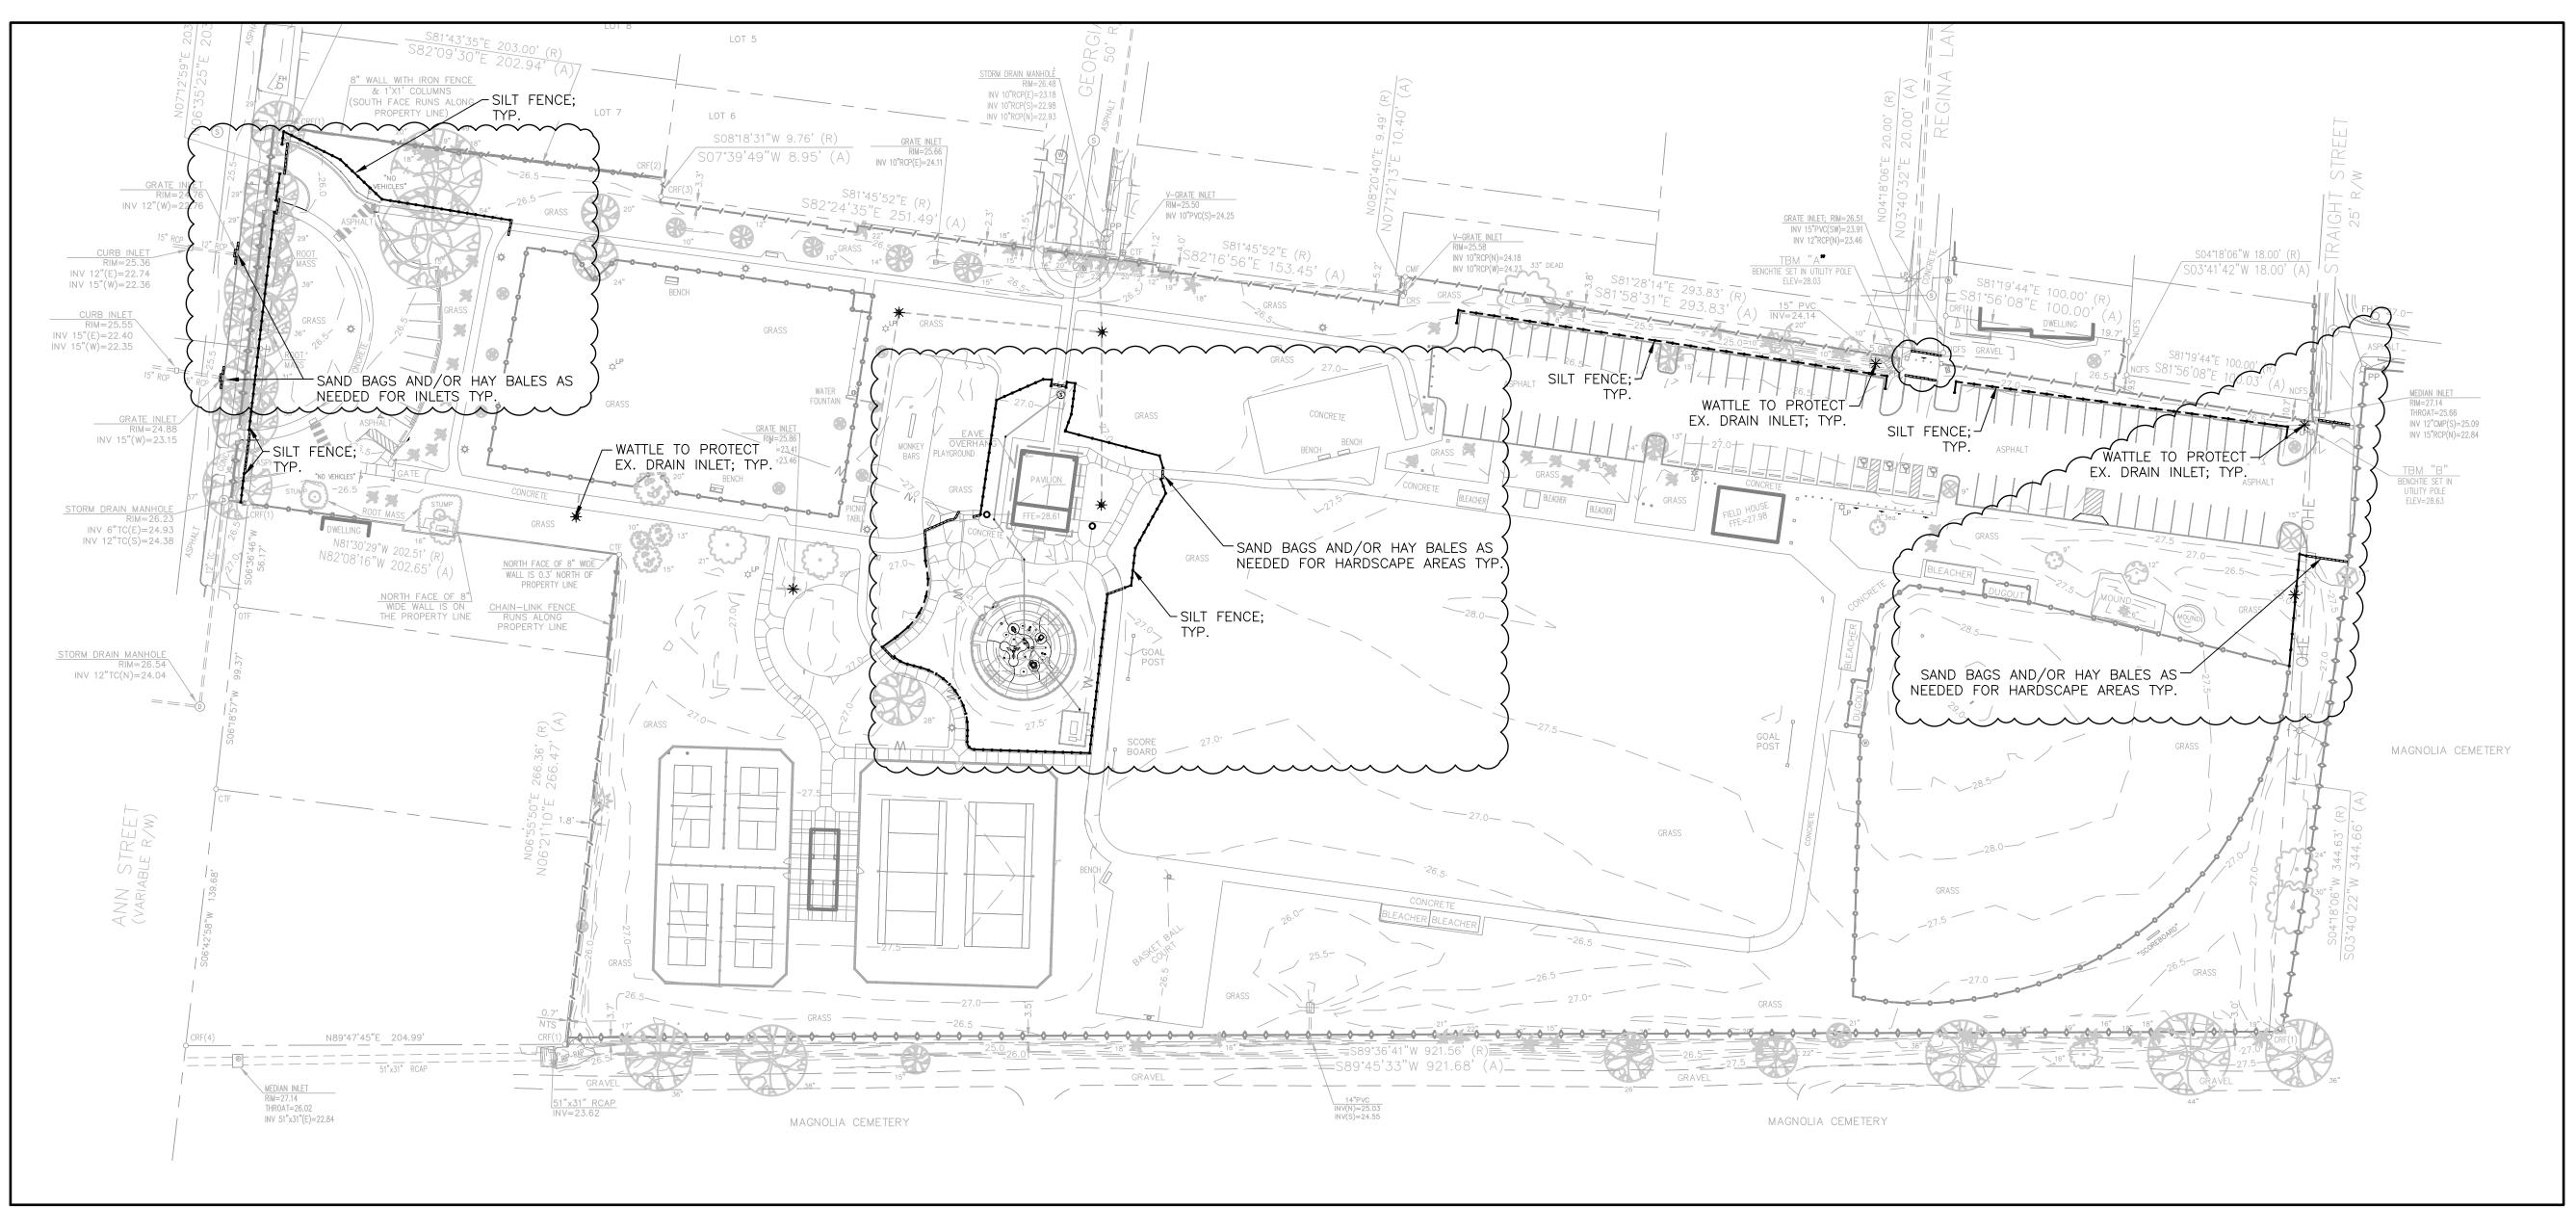


MACHINE TRENCHED GEOTEXTILE SHALL BE TRENCHED AT LEAST 8" DEEP

- JOINTS IN FILTER FABRIC SHALL BE SPLICED AT

2. FILTER FABRIC FENCES SHALL BE INSTALLED ALONG CONTOUR WHENEVER POSSIBLE







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Revisions / Submissions 100% BID DRAWINGS

05.16.25 ADDENDUM 1

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EROSION CONTROL PLAN

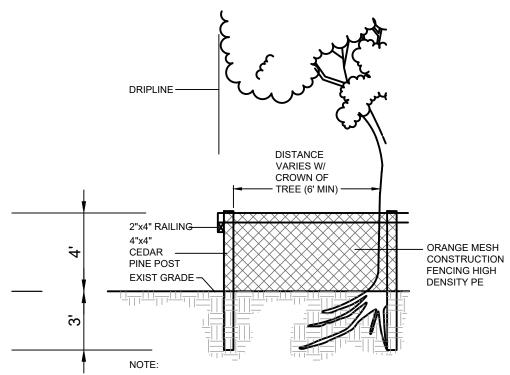
ER100

EROSION CONTROL PLAN

DEMOLITION SCHEDULE						
CODE	DESCRIPTION	ESTIMATED QTY	CODE	DESCRIPTION	STIMATED QTY	
D-101	EXISTING CONCRETE: EXCAVATE & REMOVE TO SUFFICIENT DEPTH TO INSTALL SUBGRADE/INFRASTRUCTURE; DISPOSE O	F 6,583 sf	D-109	EXISTING CHAINLINK FENCING: REMOVE EX. FENCING; DISPOS OF WASTE APPROPRIATELY.	E 220 If	
D-102	WASTE APPROPRIATELY. EXISITNG CONCRETE CURB: WHERE NECESSARY; EXCAVATE OF REMOVE EXISITING CONCRETE CURB; DISPOSE OF WASTE APPROPRIATELY.	& 17 If	D-110	EXISTING DRINKING FOUNTAIN: REMOVE EX. DRINKING FOUNTAIN (RELOCATION TBD); MAINTIAN AND PROTECT EX. WATER SUPPLY LINES (DO NOT CAP).	1	
D-103	EXISTING TREE: REMOVE EX. TREE & STUMP; BACKFILL WITH SANDY LOAM SOIL; DISPOSE OF WASTE APPROPRIATELY.	1	D-111	EXISTING TRASH RECEPTACLE: REMOVE EX. TRASH RECEPTACLE; BONNET TO BE REPLACED; TO BE RELOCATED; RELOCATION TBD.	1	
D-104	EXISTING WADING POOL: EXCAVATE TO SUFFICIENT DEPTH & REMOVE EX. POOL/FOUNTAIN STRUCTURE; DISCONNECT & CALL EX. ELECTRICAL, & PLUMBING/PIPING EQUIPMENT; DISPOS		D-112	EXISTING BENCH: REMOVE EX. BENCH; TO BE RELOCATED; RELOCATION TBD.	1	
	OF WASTE APPROPRIATELY. EXISTING ASPHALT: WHERE NECESARY; EXCAVATE & REMOVE		D-113	EXISTING GATE: REMOVE EX. GATE; BACKFILL VOIDS WITH APPROVED BACKFILL MATERIAL; DISPOSE OF WASTE APPROPRIATELY.	4	
D-105	ASPHALT TO SUFFICIENT DEPTH TO INSTALL PROPOSED PAVING; DISPOSE OF WASTE APPROPRIATELY.	- 1,004 31	D-114	EXISTING WOOD BOLLARD: EXCAVATE AND REMOVE EX. WOOI BOLLARD; BACKFILL VOIDS WITH APPROVED BACKFILL) 16	
D-106	EXISTING ASPHALT RAMP: EXCAVATE & REMOVE EX. ASPHALT RAMP; DISPOSE OF WASTE APPROPRIATELY.	48 sf		MATERIAL; DISPOSE OF WASTE APPROPRIATELY.		
D-107	EXISTING ASPHALT PAVING: CLEAN EX. ASPHALT; SAWCUT & REMOVE ALL POTHOLES & DAMAGED ASPHALT THROUGHOUT	3	D-115	EXISTING ADA SIGNAGE: EXCAVATE & REMOVE EX. ADA SIGNAGE; DISPOSE OF WASTE APPROPRIATELY.	2	
	ALL PARKING AREAS AS REQ.		D-116	TREE PROTECTION FENCING; AS REQ.		
D-108	EXISTING ASPHALT: MILL 1" OF EX. ASPHALT PAVING; DISPOSE OF WASTE APPROPRIATELY.	7,832 sf				

QUANTITIES NOTED ON PLANS ARE OFFERED AS A CONVENIENCE TO THE CONTRACTOR FOR BID PURPOSES ONLY. CONTRACTOR SHALL VERIFY ALL QUANTITIES AND REPORT ANY DISCREPANCIES TO THE LANDSCAPE ARCHITECT.

- REMOVE & SALVAGE ALL SIGNAGE & GRAPHICS, DELIVER TO OWNER AT DESIGNATED LOCATION. MATERIAL HAVING SALVAGE VALUE SHALL BECOME THE PROPERTY OF THE OWNER, ALL OTHER MATERIAL AND DEBRIS ACCUMULATED AS A RESULT OF DEMOLITION SHALL BECOME THE PROPERTY OF THE CONTRACTOR AND SHALL BE REMOVED FROM THE PREMISES BY THE CONTRACTOR AND DISPOSED OF IN A LEGAL AND PROPER MANNER.
- FURNISH, INSTALL, AND MAINTAIN IN SAFE CONDITIONS AT ALL TIMES TEMPORARY PROTECTION REQUIRED TO ENSURE SAFETY FOR PERSONS AND PROPERTY DURING DEMOLITION AND REMOVAL
- ALL ELECTRICAL, PLUMBING, AND MECHANICAL WORK (DEMOLITION AND NEW) IS TO BE PERFORMED BY LICENSED, COMPETENT CONTRACTORS.
- FILL MATERIAL SHALL BE SATISFACTORY SOIL: A SANDY LOAM TEXTURE FREE OF ROCK OR GRAVEL LARGER THAN 3" IN ANY DIMENSION, DEBRIS, WASTE, FROZEN MATERIALS, VEGETATION, OR OTHER DELETERIOUS MATTER.
- CLEAR AND GRUB ALL LANDSCAPE AREAS INDICATED. BACKFILL ANY VOIDS TO MATCH EXISTING
- 6.1. "CLEAR AND GRUB" SHALL INCLUDE REMOVAL OF GRASS, SHRUBS, AND UNDERBRUSH, REMOVAL OF ROOTS, ROUGH GRADING, INSTALLATION OF LOAM (IF APPLICABLE), FINE GRADING, SEEDING AND TURF ESTABLISHMENT BY THE CONTRACTOR.
- TREES DESIGNATED FOR REMOVAL SHALL BE TAGGED BY CONTRACTOR AND APPROVED BY OWNER'S REPRESENTATIVE PRIOR TO COMMENCEMENT OF CONSTRUCTION.



1. PLACE BARRICADE AROUND TREES TO REMAIN PRIOR TO DEMOLITION, CLEARING, OR SITE WORK.

2. NO VEHICULAR TRAFFIC, STAGING OF CONSTRUCTION MATERIALS OR ROOT COMPACTION WITHIN TREE BARRICADES.

3. NO ROOT CUTTING, FILLING, TRENCHING, OR CORING ALLOWED WITHIN TREE BARRICADES WITHOUT APPROVAL FROM THE BASE ENGINEER PRIOR TO ACTIVITIES.

329343.06-01

POINT OF BEGINNING
S.W. CORNER OF LOT 7, BLOCK 6,
A SUBDIVISION OF
THE FRY AND DUNLOP TRACTS INV 10"PVC(S)=22.31 (DB 96, PG 255) SOUTH FACE RUNS ALONG S08°18'31"W 9.76' (R) S07°39'49"W 8.95" (A) INV 10"RCP(E)=24.11 INV 10"PVC(S)=24.25 GRATE INLET; RIM=26.51 INV 15"PVC(SW)=23.91 INV 12"RCP(N)=23.46 INV 10"RCP(N)=24.18 INV 10"RCP(W)=24.23 33" DEAD /S03°41'42"W 18.00' (RE: ELECTRICAL SHEETS CURB INLET
RIM=25.55
INV 15"(E)=22.40
INV 15"(W)=22.35 STORM DRAIN MANHOLF RIM=26.2 STORM DRAIN MANHOLE RIM=26.54 INV 12"TC(N)=24.04 MAGNOLIA CEMETERY INV 51"x31"(E)=22.84 MAGNOLIA CEMETERY MAGNOLIA CEMETERY

landscape architects www.was-design.com

land planning placemaking

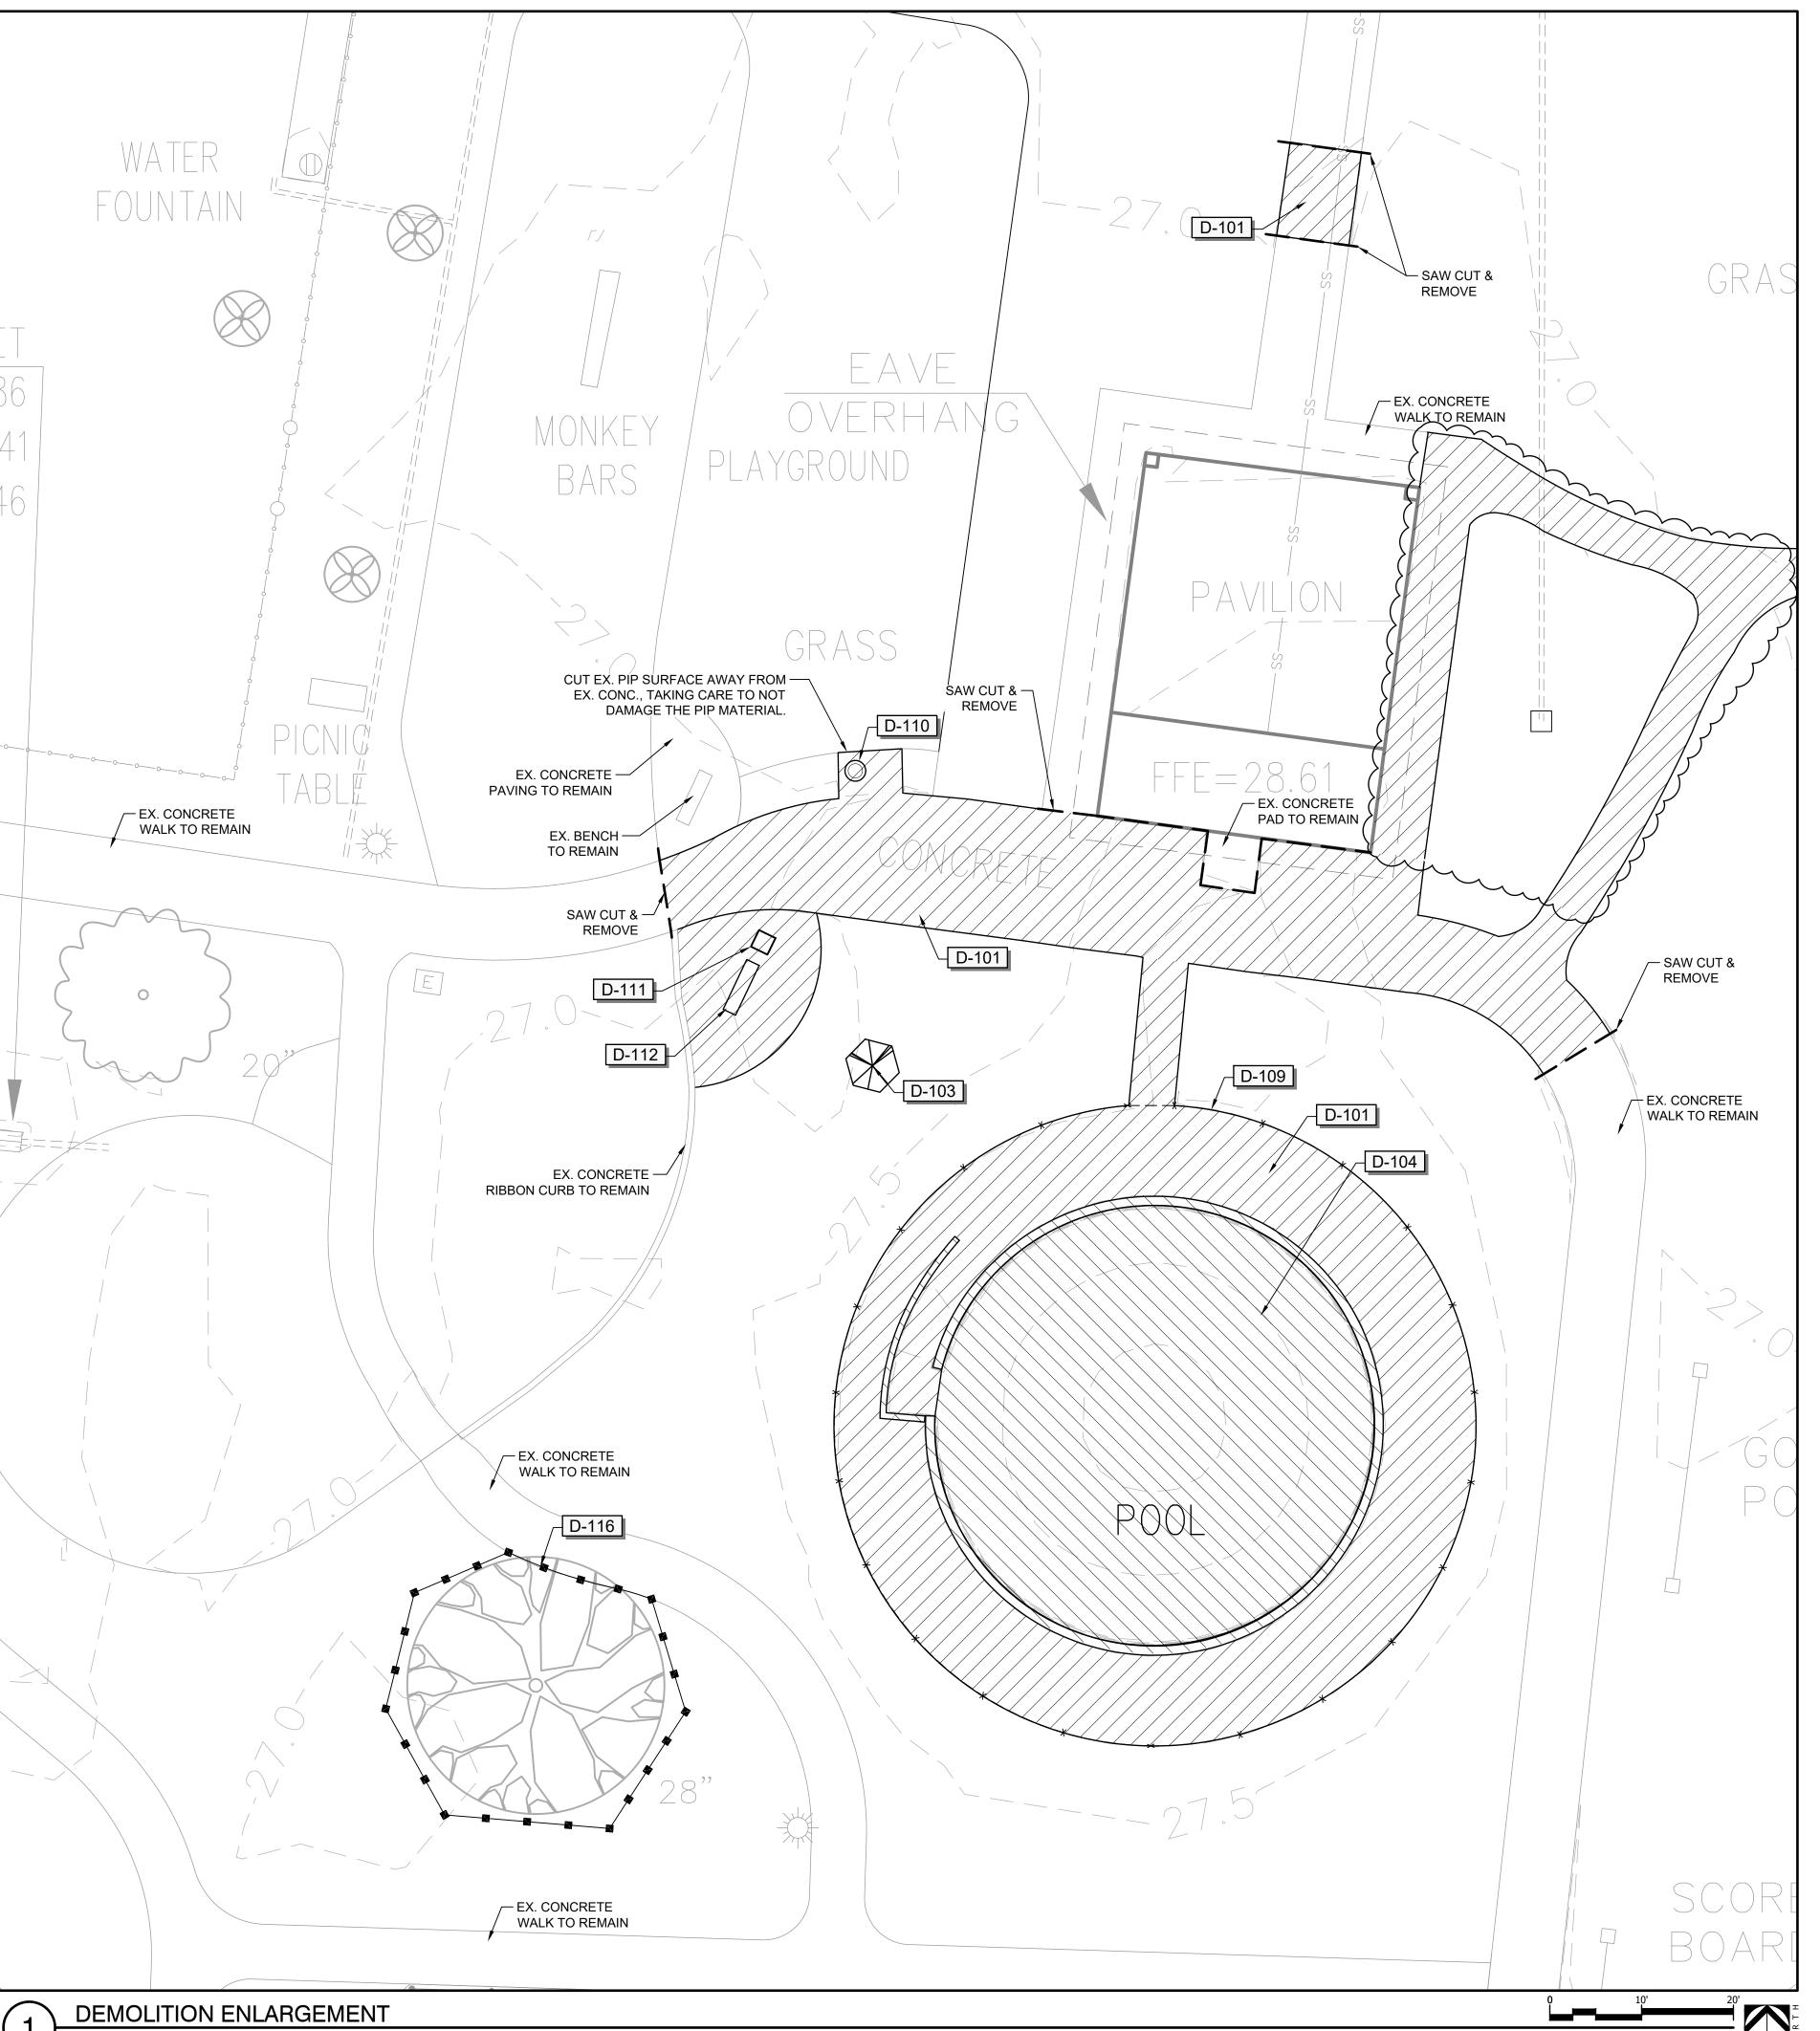
05.16.25 ADDENDUM 1

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DEMOLITION PLAN

DP100

DEMOLITION PLAN



DEMOLITION SCHEDULE SPLASH PAD ESTIMATED QTY CODE **DESCRIPTION** EXISTING CONCRETE: EXCAVATE & REMOVE TO SUFFICIENT (6,216 sf D-101 DEPTH TO INSTALL SUBGRADE/INFRASTRUCTURE; DISPOSE OF WASTE APPROPRIATELY. EXISTING TREE: REMOVE EX. TREE & STUMP; BACKFILL WITH 1 SANDY LOAM SOIL; DISPOSE OF WASTE APPROPRIATELY. EXISTING WADING POOL: EXCAVATE TO SUFFICIENT DEPTH & 1,970 sf REMOVE EX. POOL/FOUNTAIN STRUCTURE; DISCONNECT & CAP ALL EX. ELECTRICAL, & PLUMBING/PIPING EQUIPMENT; DISPOSE OF WASTE APPROPRIATELY. EXISTING CHAINLINK FENCING: REMOVE EX. FENCING; DISPOSE 220 If OF WASTE APPROPRIATELY. EXISTING DRINKING FOUNTAIN: REMOVE EX. DRINKING FOUNTAIN (RELOCATION TBD); MAINTIAN AND PROTECT EX. WATER SUPPLY LINES (DO NOT CAP). EXISTING TRASH RECEPTACLE: REMOVE EX. TRASH RECEPTACLE; BONNET TO BE REPLACED; TO BE RELOCATED; RELOCATION TBD. EXISTING BENCH: REMOVE EX. BENCH; TO BE RELOCATED; 1 RELOCATION TBD.

QUANTITY TAKEOFF DISCLAIMER:

TREE PROTECTION FENCING; AS REQ.

D-116

QUANTITIES NOTED ON PLANS ARE OFFERED AS A CONVENIENCE TO THE CONTRACTOR FOR BID PURPOSES ONLY. CONTRACTOR SHALL VERIFY ALL QUANTITIES AND REPORT ANY DISCREPANCIES TO THE LANDSCAPE ARCHITECT.



Revisio	ons	
No.	Date	Revisions / Submissions
	05.07.25	100% BID DRAWINGS
	05.16.25	ADDENDUM 1

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WP	Registration
awn	
CT	(XE)
oject Manager	
EC	
incipal	R. A. JACO
46010-032	- 13MM
oject No.	
2.13.25	TOPED LAN
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DEMOLITION ENLARGEMENT

DP201

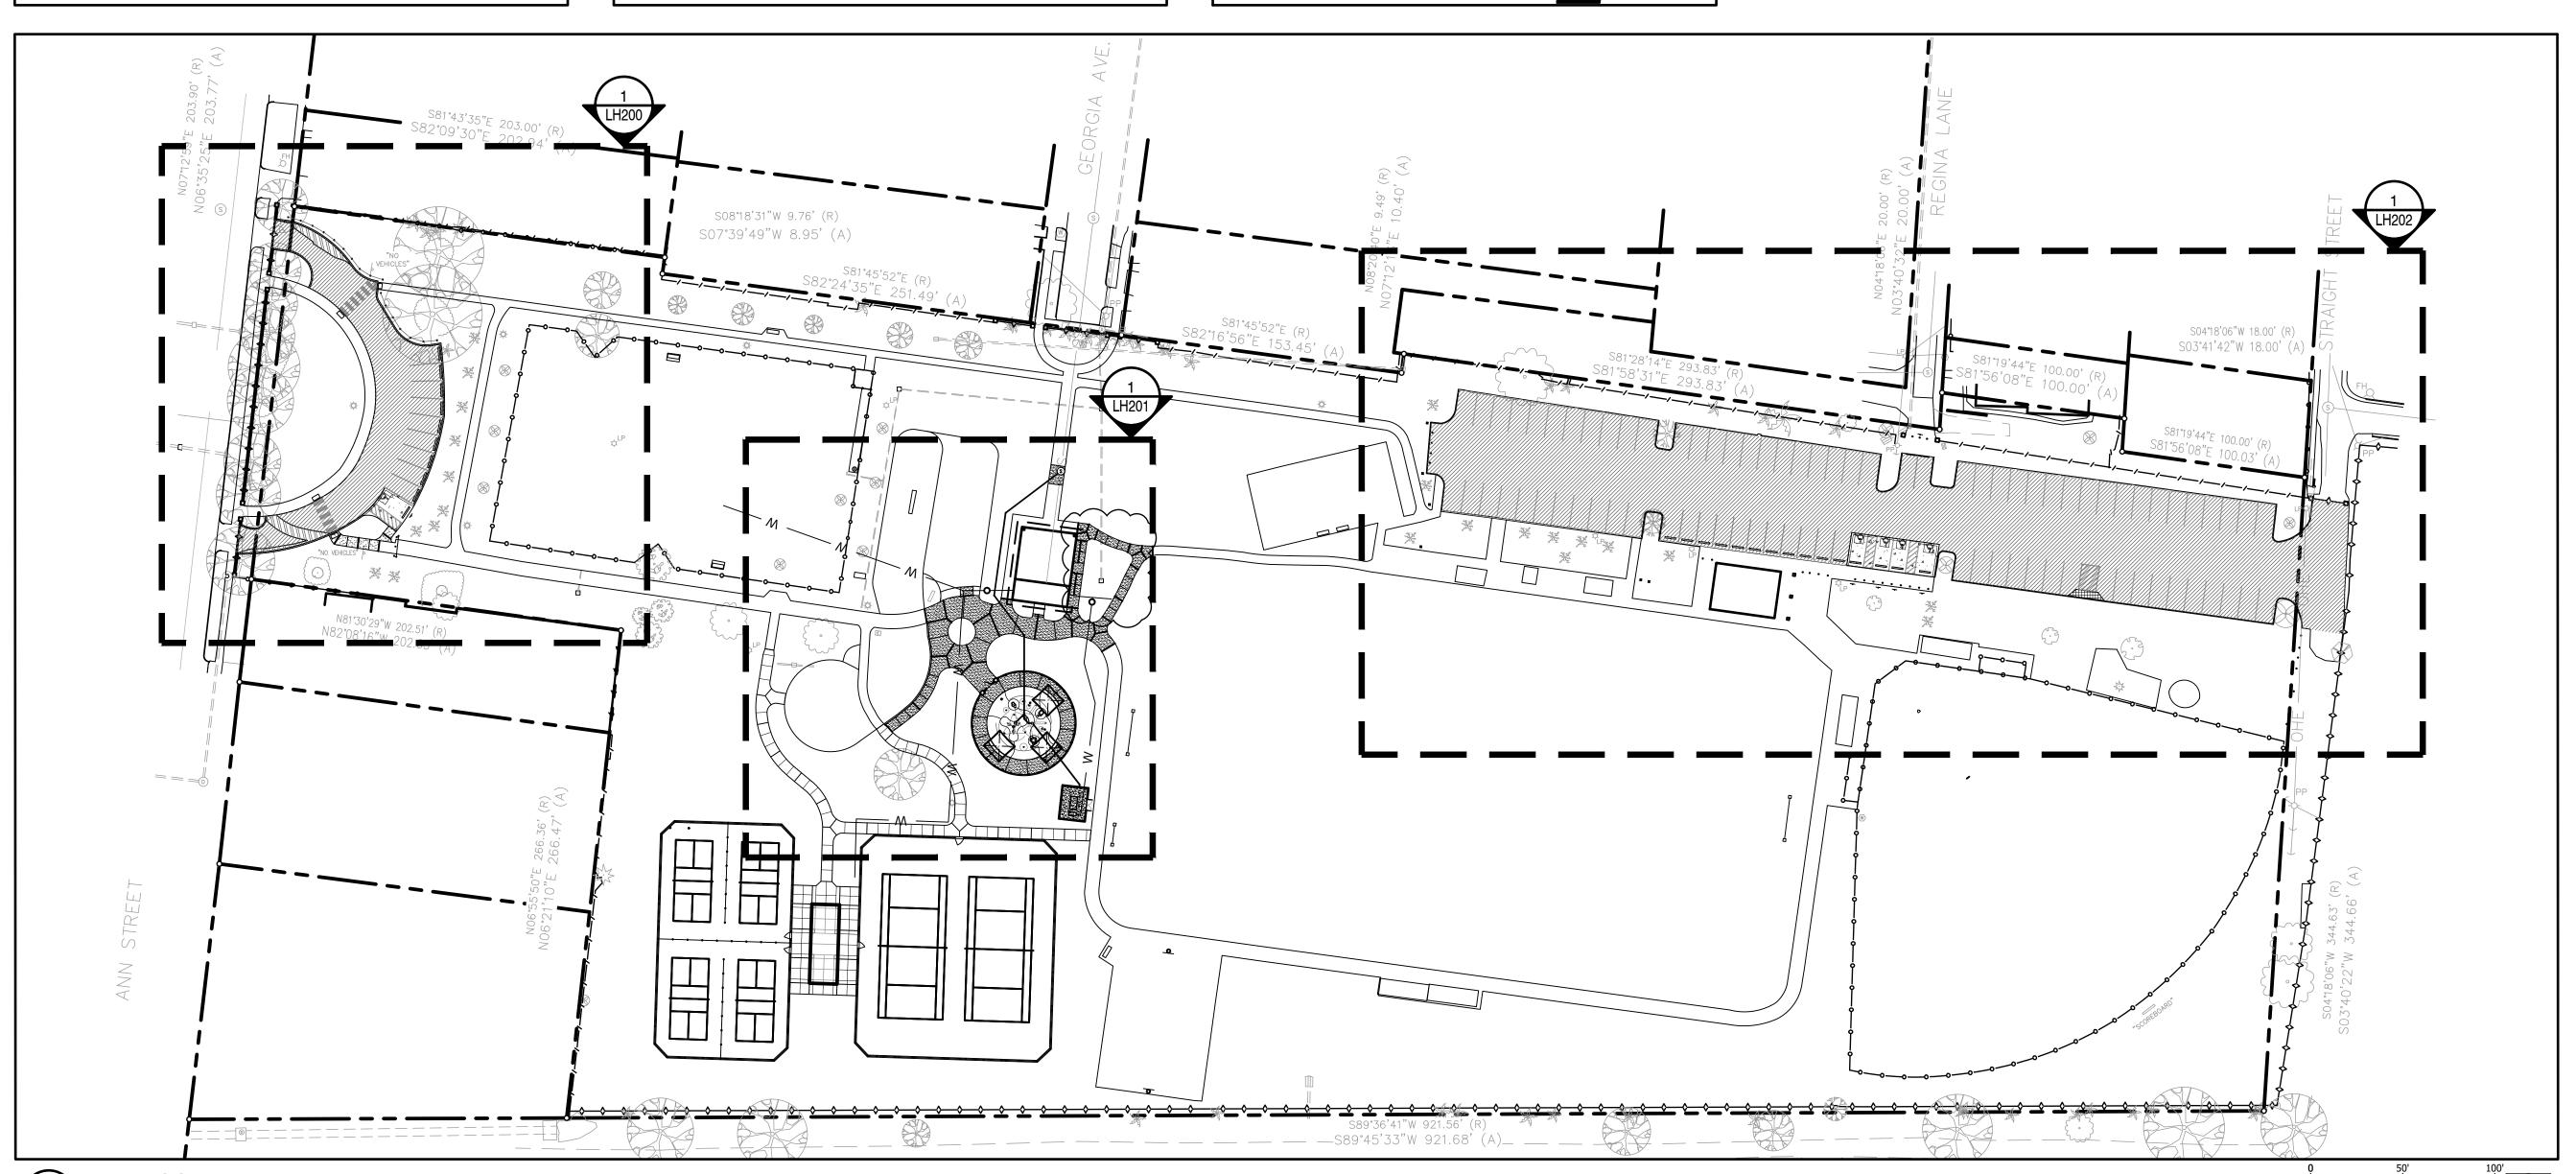
32 EXTER	IOR IMPROVEMENTS SCHEDULE										
CODE	DESCRIPTION	<u>QTY</u>	<u>DETAIL</u>	CODE	DESCRIPTION	STIMATED QTY	DETAIL	CODE	DESCRIPTION	ESTIMATED QTY	DETAIL
32-01	CONCRETE: PEDESTRIAN PAVING; 4" - 3,000 PSI; FIBER REINFORXED; LIGHTBROOM FINISH; COLOR NATURAL GRAY.	(4,517 sf)	1/LH500	32-15	STRIPING: PEDESTRIAN CROSSWALK; 6' WIDE, 2' THICK TYP.; COLOR: WHITE; PER LOCAL CODE REQUIREMENTS.	44 If	2/LH501	32-26	BENCH: SPLASH PAD; CONCRETE: 3,000 PSI; REINFORCED 60 KSI STEEL; COLOR: NATURAL GRAY.	37 lf	1
32-02	CONCRETE: VEHICULAR PAVING; 6"- 4000 PSI; REINFORCED 60 KSI STEEL; NATURAL BROOM FINISH; EXPANSION JOINTS MAX 20'; COLOR: NATURAL GRAY.	1,184 sf	3/LH500	32-16	SIGNAGE: ADA VAN ACCESSIBLE PARKING; PER ADA REQUIREMENTS.	2	3/LH501	32-27	FENCE: SPLASH PAD; 48" COMMERCIAL GRADE ALUM. BY "AMERISTAR" OR APPROVED EQUAL; POWDER COATED FINISH	169 lf l;	1/LH502
32-03	CONCRETE: RIBBON CURB; 8"X8"- 3,000 PSI; NATURAL BROOM FINISH; COLOR: NATURAL GRAY.	335 lf	6/LH500	32-17	SIGNAGE: ADA ACCESSIBLE PARKING; PER ADA REQUIREMENTS.	3			COLOR: BRONZE; 2-1/2" LINE @ 5`0" O.C.; 2" FLAT TOP, INTERMEDIATE, & BOTTOM RAIL; 1" PICKETS @ 4" O.C.; FENCE PANELS & PICKETS EQUAL DISTANCE BETWEEN POST; SUBMIT SHOP DRAWINGS FOR APPROVAL.	-	
32-04	CONCRETE: STANDING CURB; 6" - 3,000 PSI; TO BE NATURAL GRAY IN COLOR.	13 lf	7/LH500	32-18	SIGNAGE: SPLASH PAD RULES; TO BE MOUNTED ON FENCE AT POINT OF ENTRY; SUBMIT SHOP DRAWINGS (INCLUDING MOUNTING HARDWARE) FOR APPROVAL.	1		32-28	GATE: SPLASH PAD; 48" WIDE COMMERCIAL GRADE ALUM. BY "AMERISTAR" OR APPROVED EQUAL; POWDER COATED FINISH	1 ;	1/LH502
32-05	CONCRETE: TURN DOWN EDGE; 8"- 4,000 PSI.	116 lf	3/LH500	32-19	SIGNAGE: PROVIDE AND INSTALL R11-2 "ROAD CLOSED" PER LOCAL CODE.	1			COLOR: BRONZE; SUBMIT SHOP DRAWINGS FOR APPROVAL. FENCE: EQUIPMENT ENCLOSURE; 6'-H; HORIZONTAL WOODEN	60 If	1/LH503
32-06	CONCRETE: WHEEL STOP.	25	4/LH501		BOLLARD: PRESSURE TREATED PINE; 6"X6"; PRESSURE	22	5/LH501	32-29	SLATS; COLOR: NATURAL; SEE DETAIL FOR SPECIFICATIONS.	00	17211000
32-07	CONCRETE: DETECTABLE WARNING; 2"X4"; SURFACE MOUNTED COLOR: RED; PER ADA REGULATIONS.	D; 4		32-20	TREATED TO AWPA CATEGORY UC4B; COLOR: NATURAL		0,211001		GATE: EQUIPMENT ENCLOSURE; 6' WIDE DOUBLE LEAF; HORIZONTAL WOODEN SLATS; COLOR: NATURAL; SEE DETAIL	1	1/LH503
32-08	ASPHALT: VEHICULAR PAVING; 1" ASPHALT & SUBBASE.	397 sf	4/LH500	32-21	BOLLARD: REMOVABLE; BOD: 4"x36" POST GUARD REMOVABLE STEEL BOLLARD; M# RMB436Y EMB4x12; COLOR: BY OWNER;	1	1		FOR SPECIFICATIONS.		
32-09	ASPHALT: VEHICULAR PAVING: 1" OVERLAY.	35,375 sf	5/LH500		LOCK PROVIDED BY OWNER; SUBMIT SHOP DRAWINGS FOR APPROVAL			32-31	AGGREGATE PAVING; 4" - 57 STONE; GEO-TEXTILE FABRIC UNDERLAY.	264 sf	1/LH503
32-10	ASPHALT: SERVICE ACCESS RAMP; 4'X12'.	64 sf		32-22	S.S. WIRE CABLE: TO BE ATTACHED BETWEEN 6"X6" BOLLARDS PER PLANS.	100 If	7/LH501	32-32	WATER VALVE: INSTALL SUBSURFACE WATER VALVE IN NDS 6	" 2	
32-11	STRIPING: ADA VEHICULAR STALL; 4" STRIPING TYP; COLOR: BLUE; PER ADA REQUIREMENTS.	36 If	1/LH501		COLUMN: CMU; 24"X24"; COLOR: TO MATCH EXISTING COLUMNS	2	1	02 02	ROUND VALVE BOX (OR APPROVED EQUAL). RECONNECT EX. WATER LINES.		
32-12	STRIPING: ADA ACCESS ISLE; 6" STRIPING TYP.; COLOR: BLUE;	54 If	1	32-23	AT PICKLEBALL COURTS PAVILION.		,				
	PER ADA REQUIREMENTS.			32-24	SPLASH PAD: CONCRETE; SEE SP DRAWINGS.	1,253 sf	3/LH504				
32-13	STRIPING: ADA PARKING LOGO; COLOR: BLUE; PER ADA REQUIREMENTS.	5	1/LH501	32-25	SHADE STRUCTURE: SPLASH PAD; 12`X12` W/OFFSET CANTILEVER UMBRELLA BY ULTRASITE PLAY SYSTEMS OR	3	2/LH504				
32-14	STRIPING: VEHICLE ISLE; 4" TYP.; COLOR: WHITE; PER LOCAL CODE REQUIREMENTS.	1,606 If			APPROVED EQUAL; COLOR BY OWNER; INSTAL PER MANUFACTURER'S RECOMMENDATIONS.						

QUANTITIES NOTED ON PLANS ARE OFFERED AS A CONVENIENCE TO THE CONTRACTOR FOR BID PURPOSES ONLY. CONTRACTOR SHALL VERIFY ALL QUANTITIES AND REPORT ANY DISCREPANCIES TO THE LANDSCAPE ARCHITECT.

NOTE:

APPLY AND COMPACT 1" HOT PATCH ASPHALT TO POTHOLES & DAMAGED ASPHALT AREAS PRIOR TO RESURFACING AS NEEDED; OVERLAY WITH TACKCOAT & 1" WEARING LAYER.







Crawford-Murphy Park: Splash Pad, Parking Lot

Revisio	on <u>s</u>	
No.	Date	Revisions / Submissions
	05.07.25	100% BID DRAWINGS
	05.16.25	ADDENDUM 1

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Principal	
246010-032	SKM MAGINERY () JEY
Project No.	
02.13.25	LANDSCAPE RECT
Date	

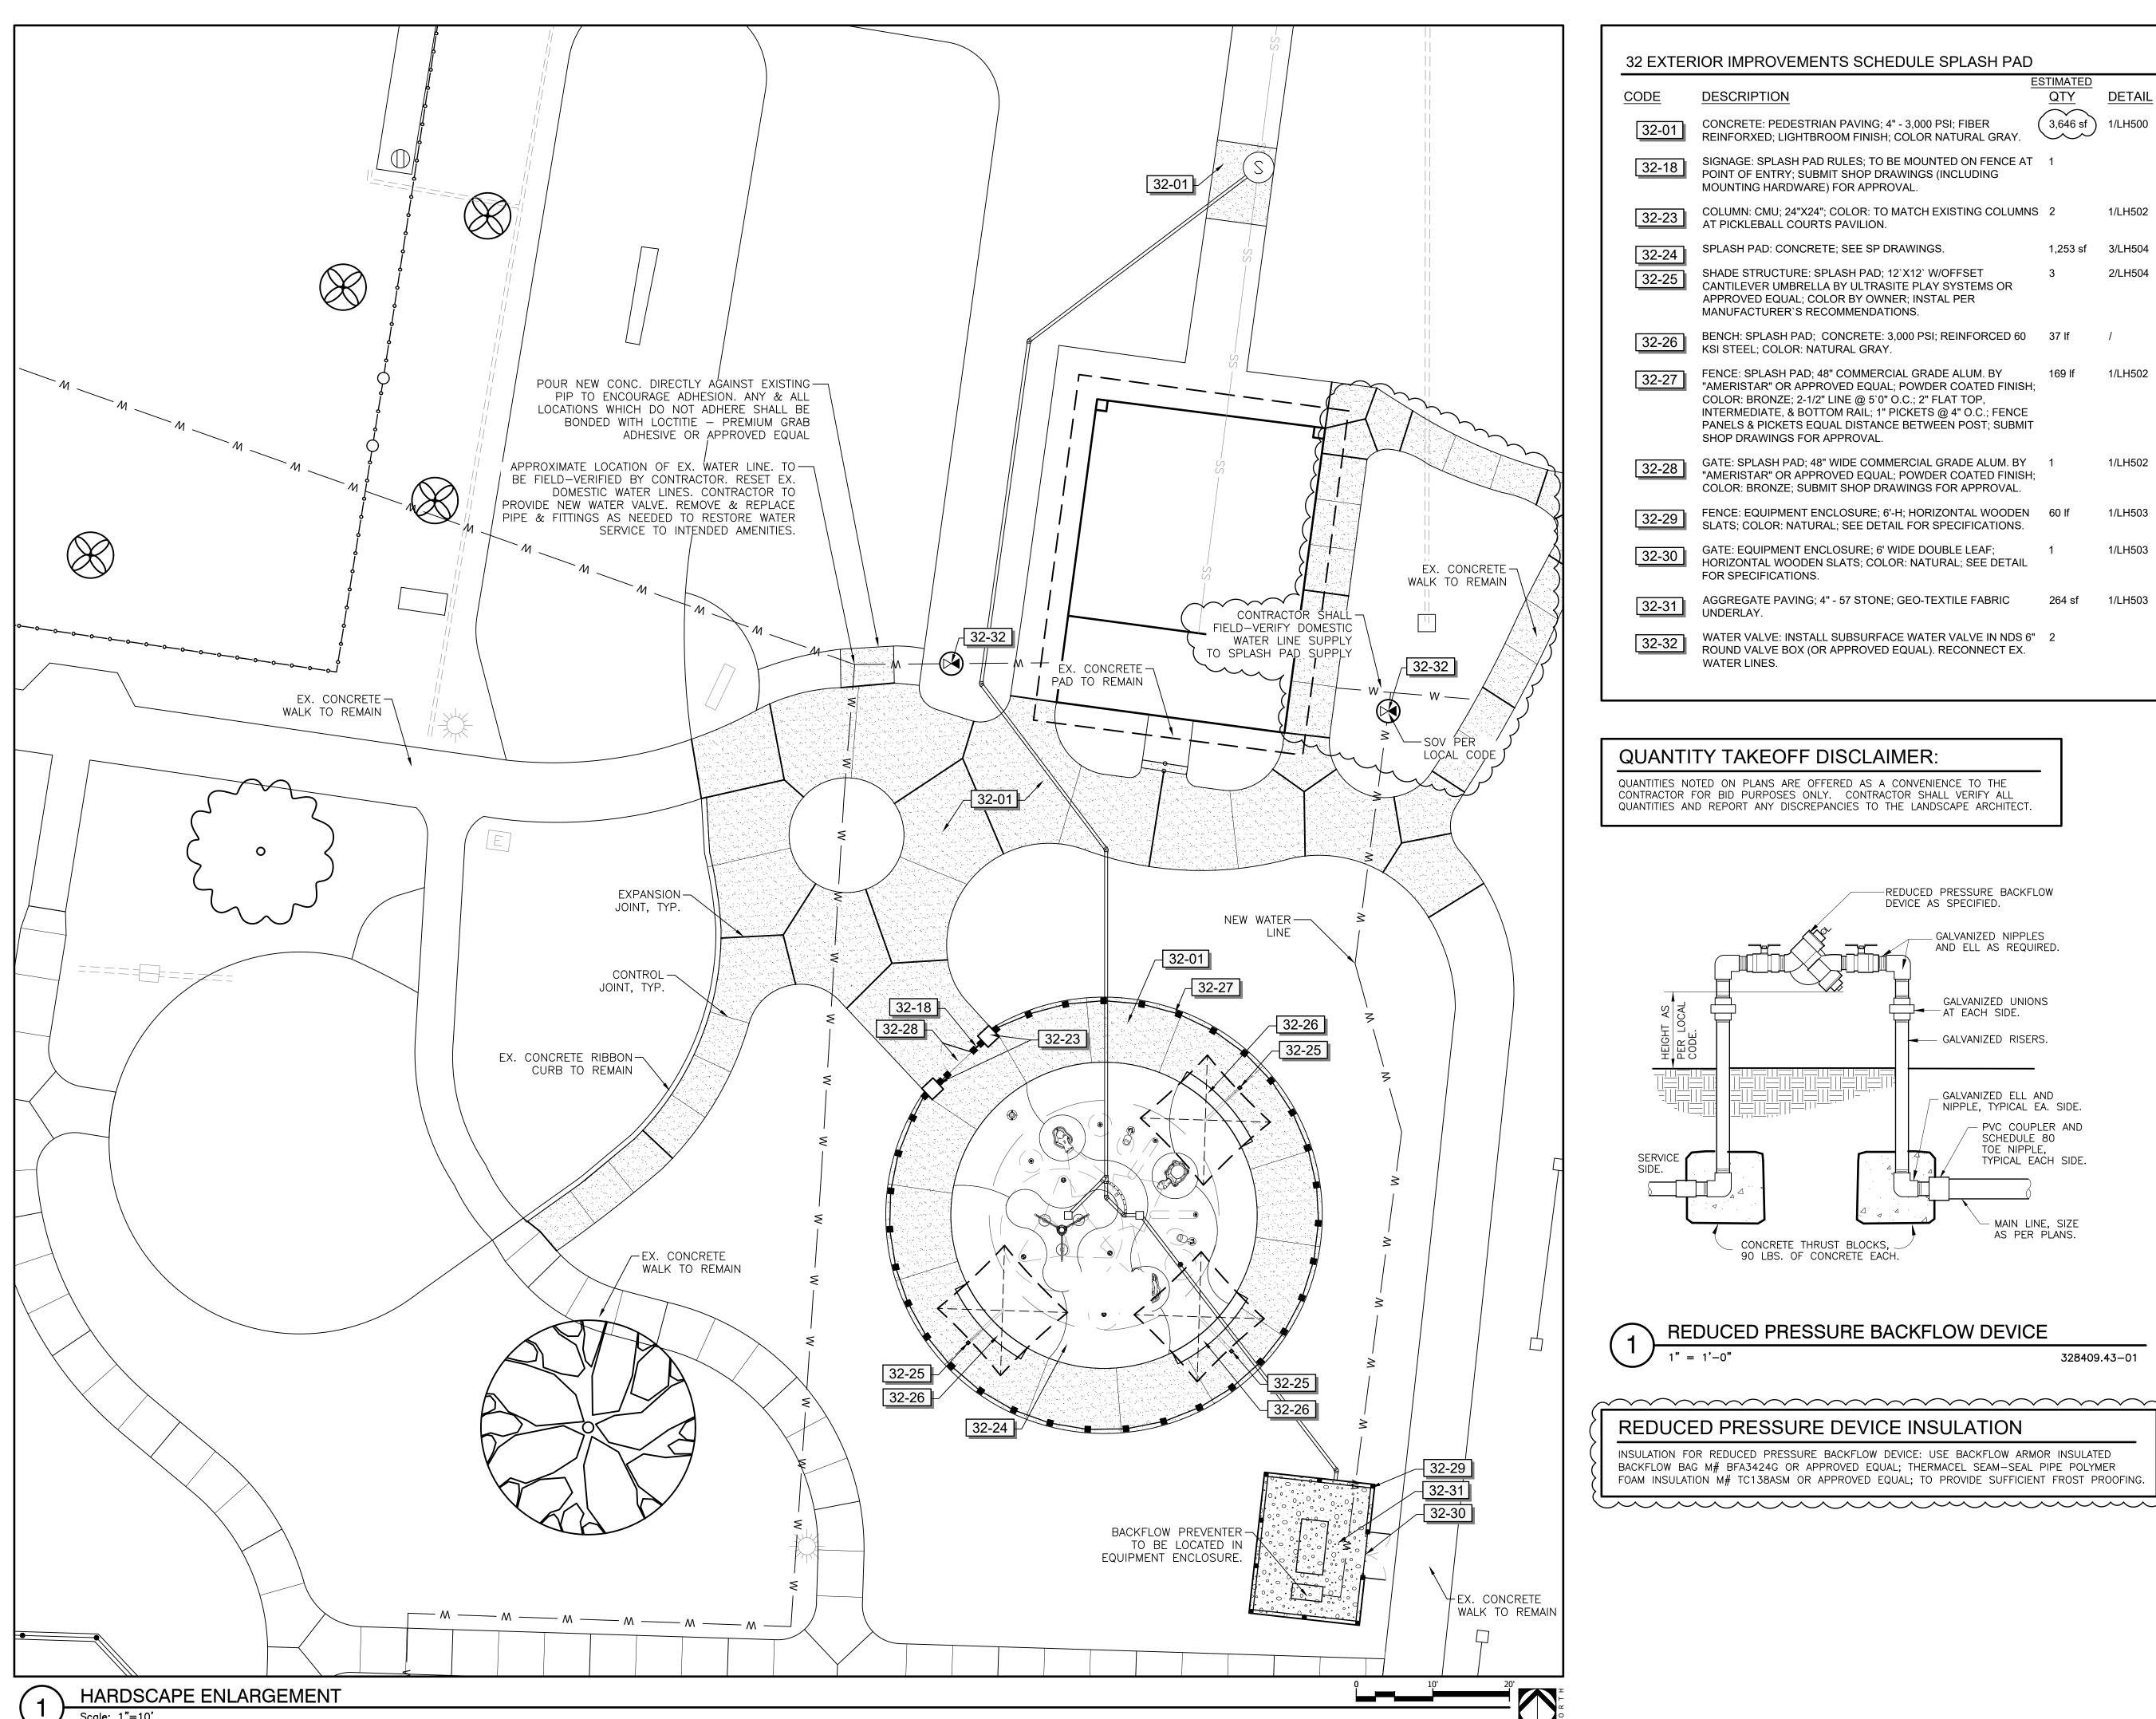
Sheet Title

HARDSCAPE PLAN

Sheet No.

LH100

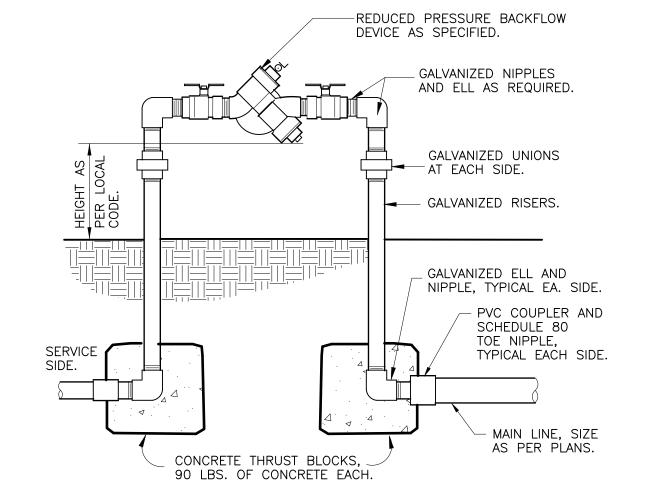
HARDSCAPE PLAN



32 EXTERIOR IMPROVEMENTS SCHEDULE SPLASH PAD **ESTIMATED** CODE DESCRIPTION <u>QTY</u> <u>DETAIL</u> 3,646 sf CONCRETE: PEDESTRIAN PAVING; 4" - 3,000 PSI; FIBER 1/LH500 REINFORXED; LIGHTBROOM FINISH; COLOR NATURAL GRAY. SIGNAGE: SPLASH PAD RULES; TO BE MOUNTED ON FENCE AT 1 POINT OF ENTRY; SUBMIT SHOP DRAWINGS (INCLUDING MOUNTING HARDWARE) FOR APPROVAL. COLUMN: CMU; 24"X24"; COLOR: TO MATCH EXISTING COLUMNS 2 1/LH502 AT PICKLEBALL COURTS PAVILION. SPLASH PAD: CONCRETE; SEE SP DRAWINGS. 1,253 sf 3/LH504 32-24 SHADE STRUCTURE: SPLASH PAD; 12'X12' W/OFFSET 2/LH504 CANTILEVER UMBRELLA BY ULTRASITE PLAY SYSTEMS OR APPROVED EQUAL; COLOR BY OWNER; INSTAL PER MANUFACTURER'S RECOMMENDATIONS. BENCH: SPLASH PAD; CONCRETE: 3,000 PSI; REINFORCED 60 37 If / KSI STEEL; COLOR: NATURAL GRAY. FENCE: SPLASH PAD; 48" COMMERCIAL GRADE ALUM. BY 169 lf 1/LH502 "AMERISTAR" OR APPROVED EQUAL; POWDER COATED FINISH; COLOR: BRONZE; 2-1/2" LINE @ 5`0" O.C.; 2" FLAT TOP, INTERMEDIATE, & BOTTOM RAIL; 1" PICKETS @ 4" O.C.; FENCE PANELS & PICKETS EQUAL DISTANCE BETWEEN POST; SUBMIT SHOP DRAWINGS FOR APPROVAL. GATE: SPLASH PAD; 48" WIDE COMMERCIAL GRADE ALUM. BY 1 1/LH502 "AMERISTAR" OR APPROVED EQUAL; POWDER COATED FINISH; COLOR: BRONZE; SUBMIT SHOP DRAWINGS FOR APPROVAL. FENCE: EQUIPMENT ENCLOSURE; 6'-H; HORIZONTAL WOODEN 60 If 1/LH503 SLATS; COLOR: NATURAL; SEE DETAIL FOR SPECIFICATIONS. GATE: EQUIPMENT ENCLOSURE; 6' WIDE DOUBLE LEAF; 1/LH503 HORIZONTAL WOODEN SLATS; COLOR: NATURAL; SEE DETAIL FOR SPECIFICATIONS. AGGREGATE PAVING; 4" - 57 STONE; GEO-TEXTILE FABRIC WATER VALVE: INSTALL SUBSURFACE WATER VALVE IN NDS 6" 2 ROUND VALVE BOX (OR APPROVED EQUAL). RECONNECT EX. WATER LINES.

QUANTITY TAKEOFF DISCLAIMER:

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REDUCED PRESSURE BACKFLOW DEVICE

328409.43-01

REDUCED PRESSURE DEVICE INSULATION

INSULATION FOR REDUCED PRESSURE BACKFLOW DEVICE: USE BACKFLOW ARMOR INSULATED BACKFLOW BAG M# BFA3424G OR APPROVED EQUAL; THERMACEL SEAM-SEAL PIPE POLYMER FOAM INSULATION M# TC138ASM OR APPROVED EQUAL; TO PROVIDE SUFFICIENT FROST PROOFING

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Revisions / Submissions

05.07.25 100% BID DRAWINGS

05.16.25 ADDENDUM 1

/P	Registration
iwn T iject Manager	JAMES JAMES
C ncipal	CROWED X
6010-032 ject No.	6 LANDSCAPE NO
2.13.25 e	LANDSCAPE

HARDSCACE **ENLARGEMENT**

LH201

PLANT	SCH	EDULE					
SYMBOL	CODE	<u>QTY</u>	COMMON / BOTANICAL NAME	CONT	CAL	<u>HT</u>	_
TREES							
	VC	2	Chaste Tree / Vitex agnus-castus MINIMUM 3 TRUNKS; MINIMUM 1" CAL PER TRUNK	B&B or Cont	3"Cal	6`-8`	
SYMBOL	CODE	<u>QTY</u>	COMMON / BOTANICAL NAME	CONT	<u>HT</u>	W	SPACING
SHRUBS							
33000000000000000000000000000000000000	MS	25	Adagio Eulalia Grass / Miscanthus sinensis 'Adagio'	3 gal			36" o.c.
•	LI	87	Breeze™ Mat Rush / Lomandra longifolia 'Breeze'	3 gal			24" o.c.
£	PD	26	Dwarf Pringles Yew Podocarpus / Podocarpus macrophyllus `Dwarf Pringles`	7 gal			36" o.c.
•	MC	45	Pink Muhly Grass / Muhlenbergia capillaris	3 gal			30" o.c.
SYMBOL	CODE	<u>QTY</u>	COMMON / BOTANICAL NAME	CONT	<u>HT</u>		SPACING
SOD	СТ	6,858 sf	Tif 419 Bermudagrass / Cynodon dactylon `Tif 419`	sod			

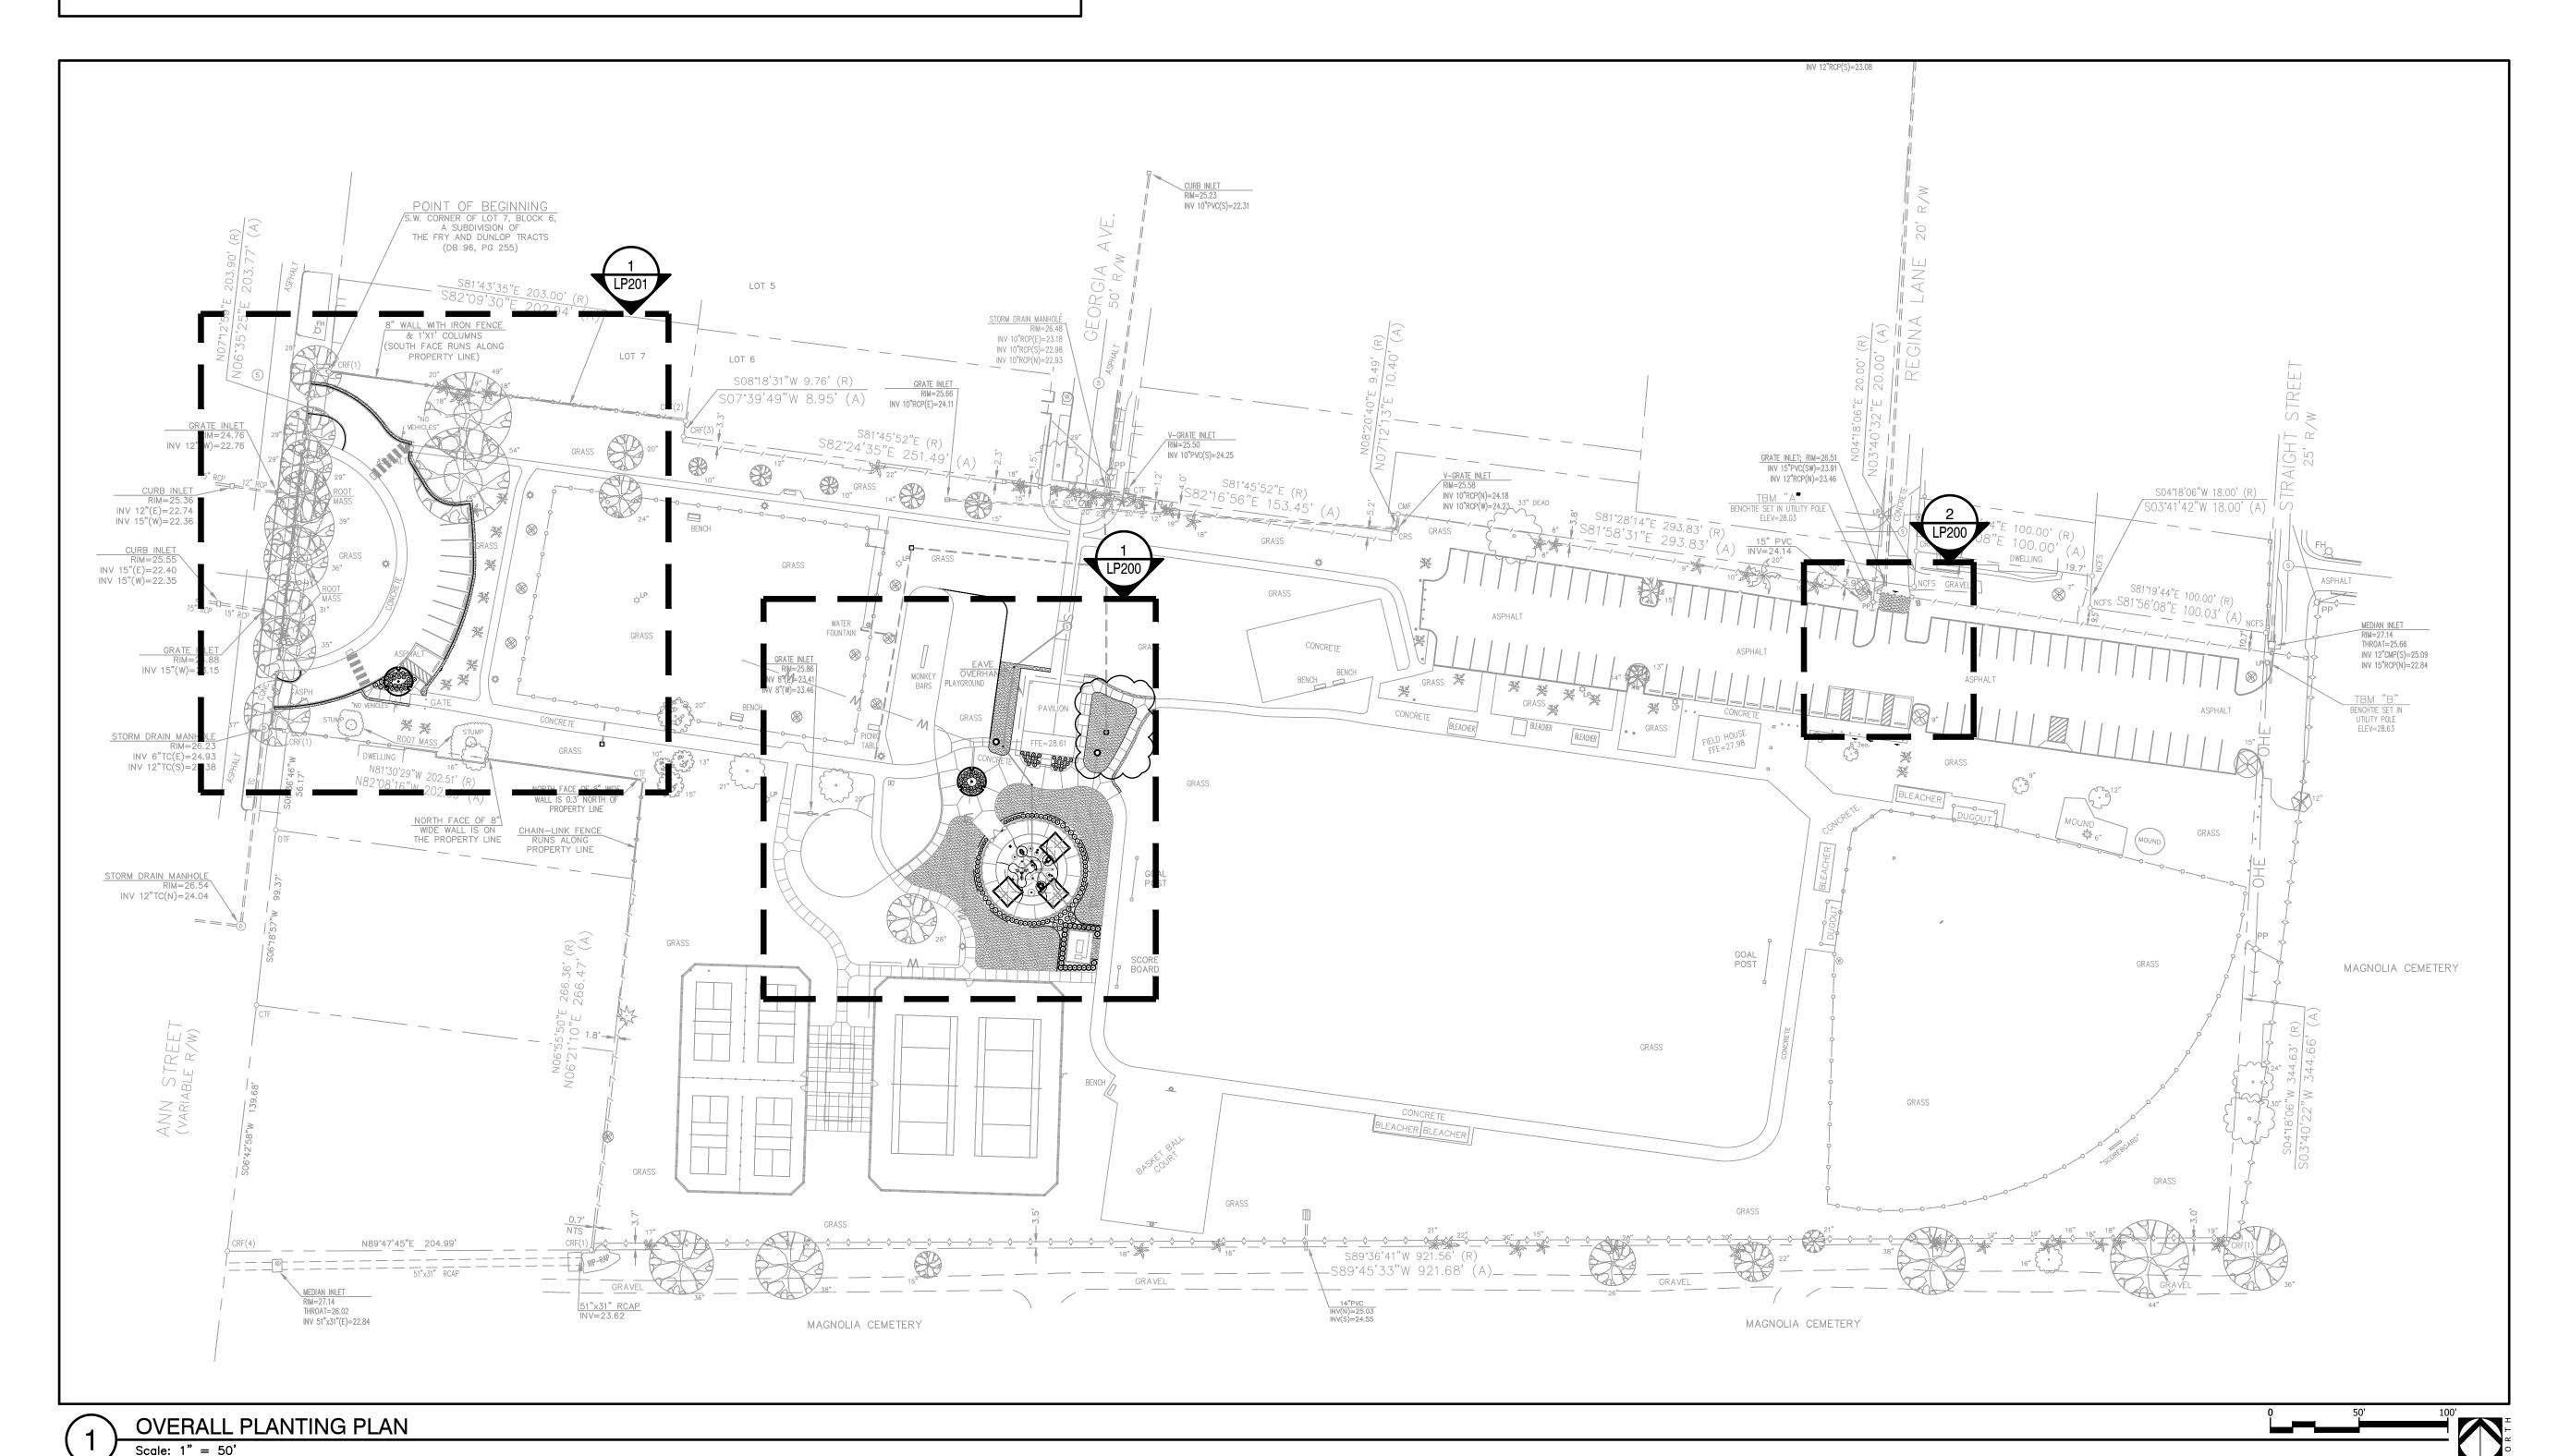
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NOTE

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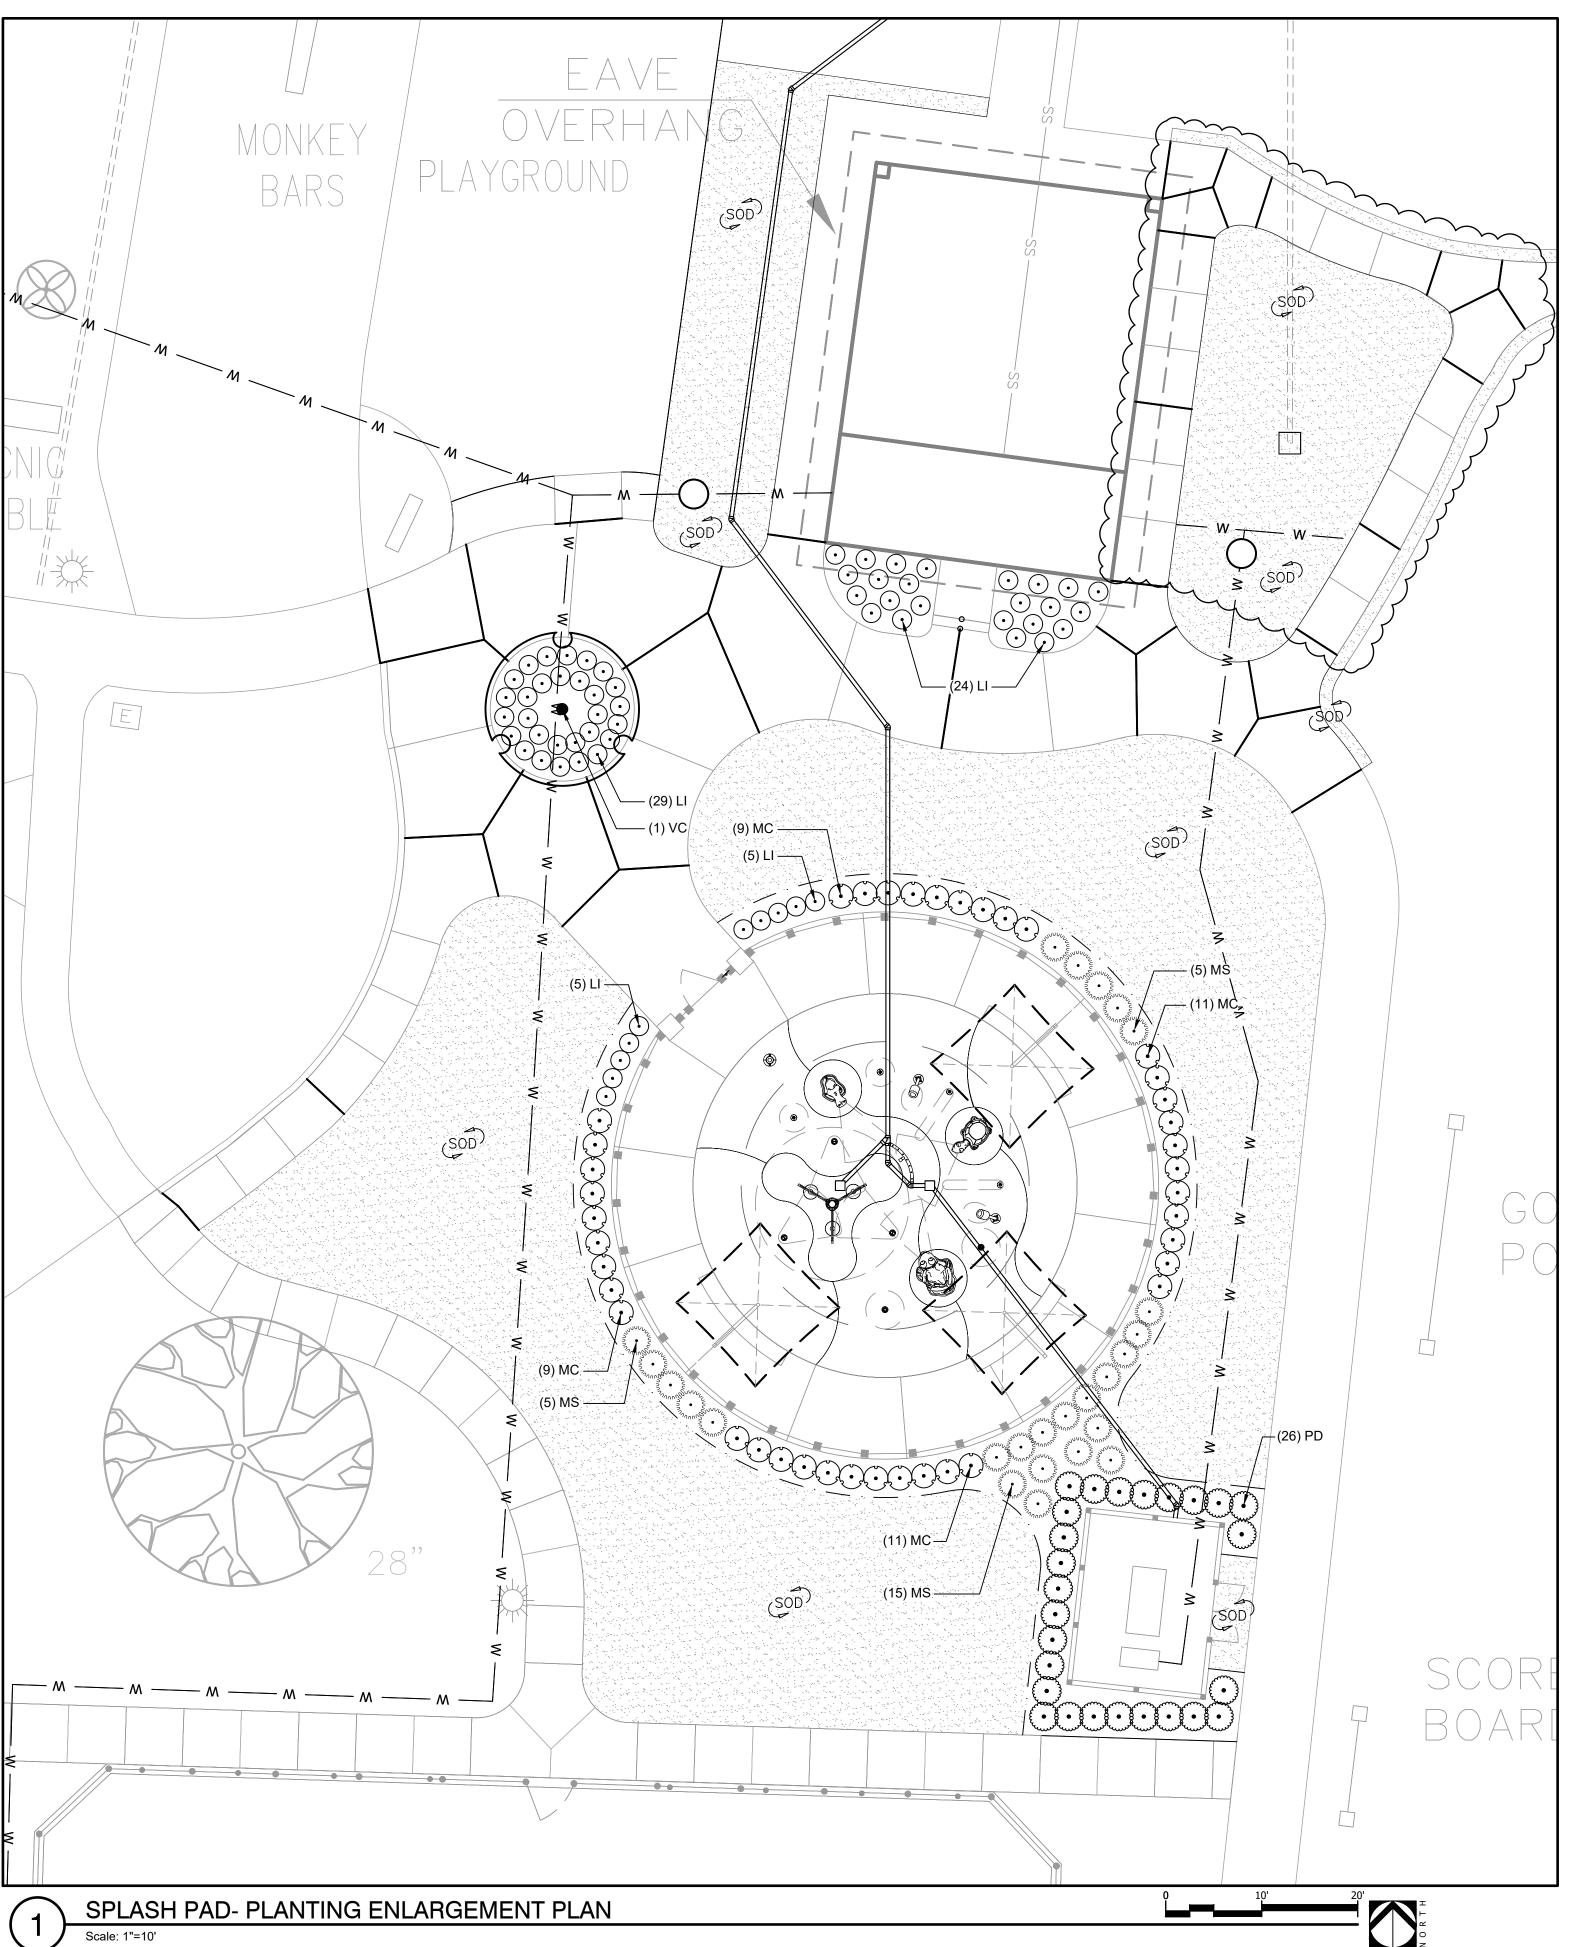
Crawford-Murphy Park: Splash Pad, Parking Lot

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LANDSCAPE PLANTING PLAN

eet No.

LP100



1 17 (141 0		STIMATED	SH PAD					
SYMBOL	CODE	QTY	BOTANICAL NAME	COMMON NAME	CONT	<u>CAL</u>	<u>HT</u>	
TREES								
	VC	1	Vitex agnus-castus MINIMUM 3 TRUNKS; MINIMUM 1" CAL	Chaste Tree	B&B or Cont	3"Cal	6`-8`	
	_	-071844755	PER TRUNK					
SYMBOL	CODE	QTY	BOTANICAL NAME	COMMON NAME	CONT	<u>HT</u>	W	<u>SPACING</u>
SHRUBS								
•	LI	63	Lomandra longifolia 'Breeze'	Breeze™ Mat Rush	3 gal			24" o.c.
· · · · · · · · · · · · · · · · · · ·	MS	25	Miscanthus sinensis 'Adagio'	Adagio Eulalia Grass	3 gal			36" o.c.
•	MC	40	Muhlenbergia capillaris	Pink Muhly Grass	3 gal			30" o.c.
£(**)	PD	26	Podocarpus macrophyllus `Dwarf Pringles`	Dwarf Pringles Yew Podocarpus	7 gal			36" o.c.
SYMBOL	CODE	<u>QTY</u>	BOTANICAL NAME	COMMON NAME	CONT	<u>HT</u>		SPACING
SOD	СТ	6,263 sf	Cynodon dactylon `Tif 419`	Tif 419 Bermudagrass	sod			

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NOTE

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NCFS NCFS	GRAVEL
	AS
2 EAST PARKINGLOT - PLANTING ENLARGEMENT Scale: 1"=10'	10' 20' II
Scale: 1 - 10	Z

A Landscape Development Plan for two ford-Murphy Park; ash Pad, Parking Lot & Lighting

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Crawford Splash Po

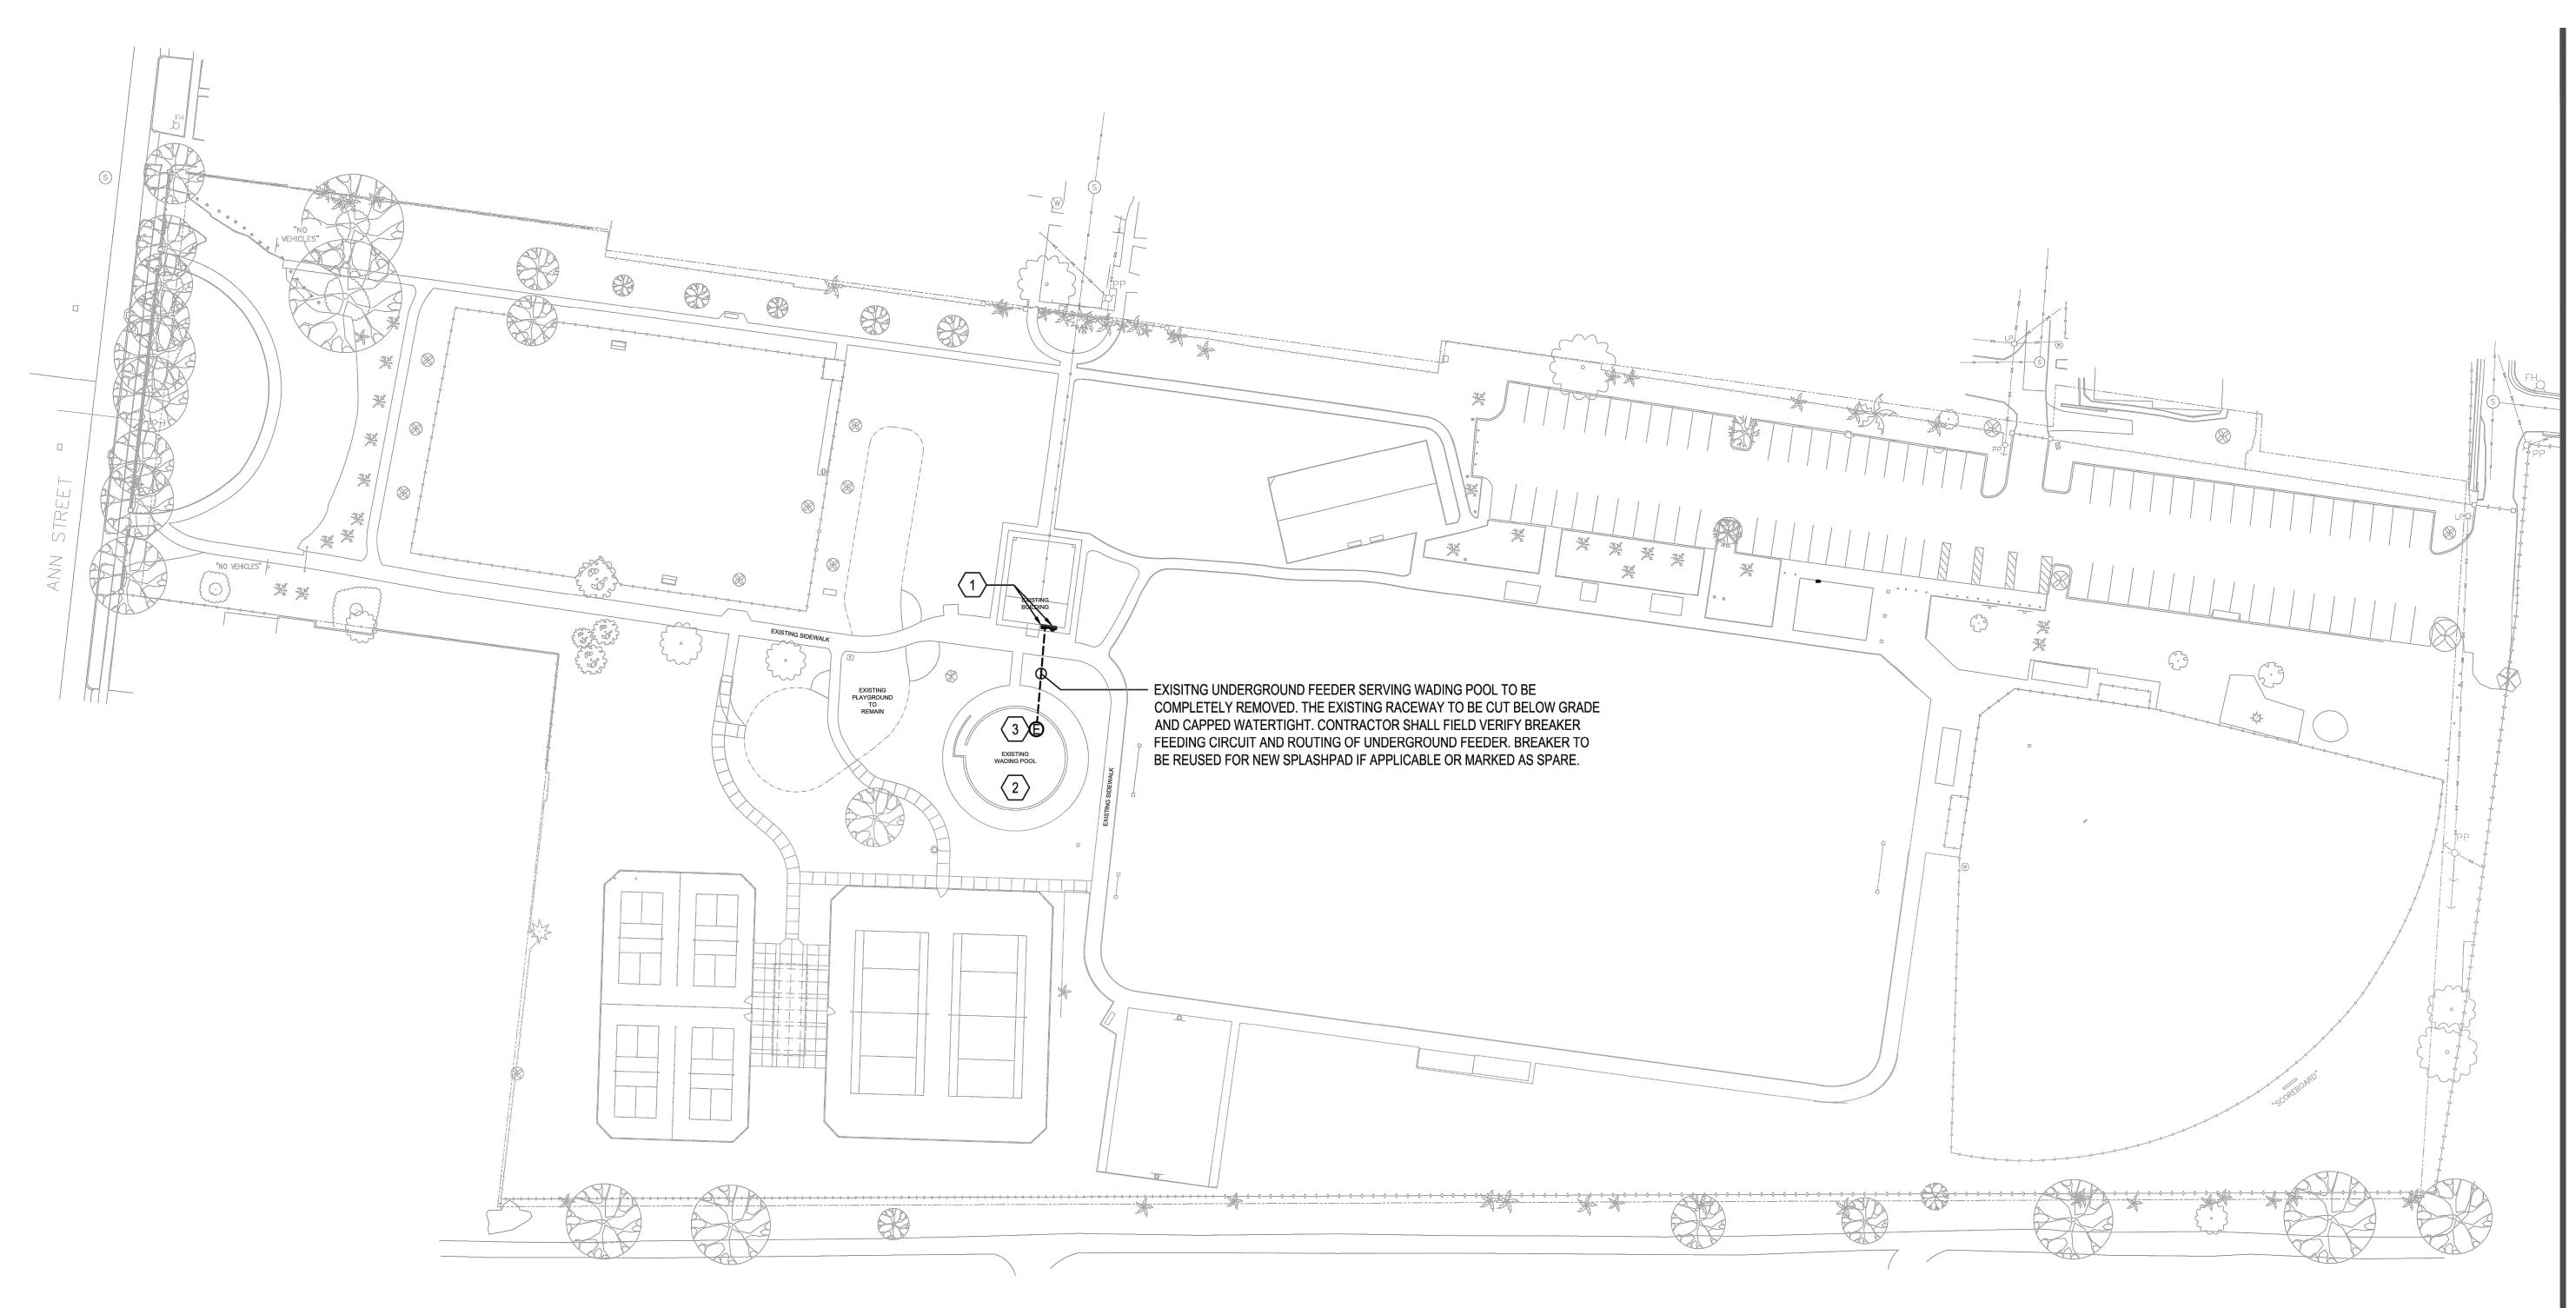
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Sheet Title

PLANTING ENLARGEMENT

Sheet I

LP200



- 1 APPROXIMATE LOCATION OF EXISTING 240 VOLT 125A 1Ø SERVICE TO REMAIN. MODIFY PER NEW WORK PLANS.
- 2 APPROXIMATE LOCATION OF EXISTING WADING POOL TO BE DEMOLISHED BY OTHERS.
- APPROXIMATE LOCATION OF EXISTING WADING POOL POWER CONNECTION TO BE REMOVED. INCLUDED IN THE ELECTRICAL CONTRACTORS SCOPE OF WORK IS TO FIELD VERIFY CIRCUIT SERVING THE EXISTING WADING POOL AND COMPLETELY REMOVE THE EXISTING CONDUCTORS. THE EXISTING RACEWAY TO BE CUT BELOW GRADE AND CAPPED

GENERAL NOTE(S)

1. IT IS THE RESPONSIBILITY OF THE CONTRACTOR TO LOCATE ALL UNDERGROUND UTILITIES. NEW CONDUITS INSTALLED ARE TO BE INSTALLED TO AVOID CONFLICT WITH EXISTING TREE ROOT SYSTEMS AS WELL AS EXISTING UTILITIES. ALL NEW UNDERGROUND CONDUITS ARE TO BE INSTALLED A MINIMUM OF 24" BELOW FINISHED GRADE.





dell consulting

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Christian Maria 50/10 Christina Marie 50660 Alabama Certificate #CA-4146-E 813 Downtowner Blvd. Ste. D Mobile, Alabama 36609 P: 251-316-0015 F: 850-332-6629 DELL CONSULTING PROJECT: 23-127

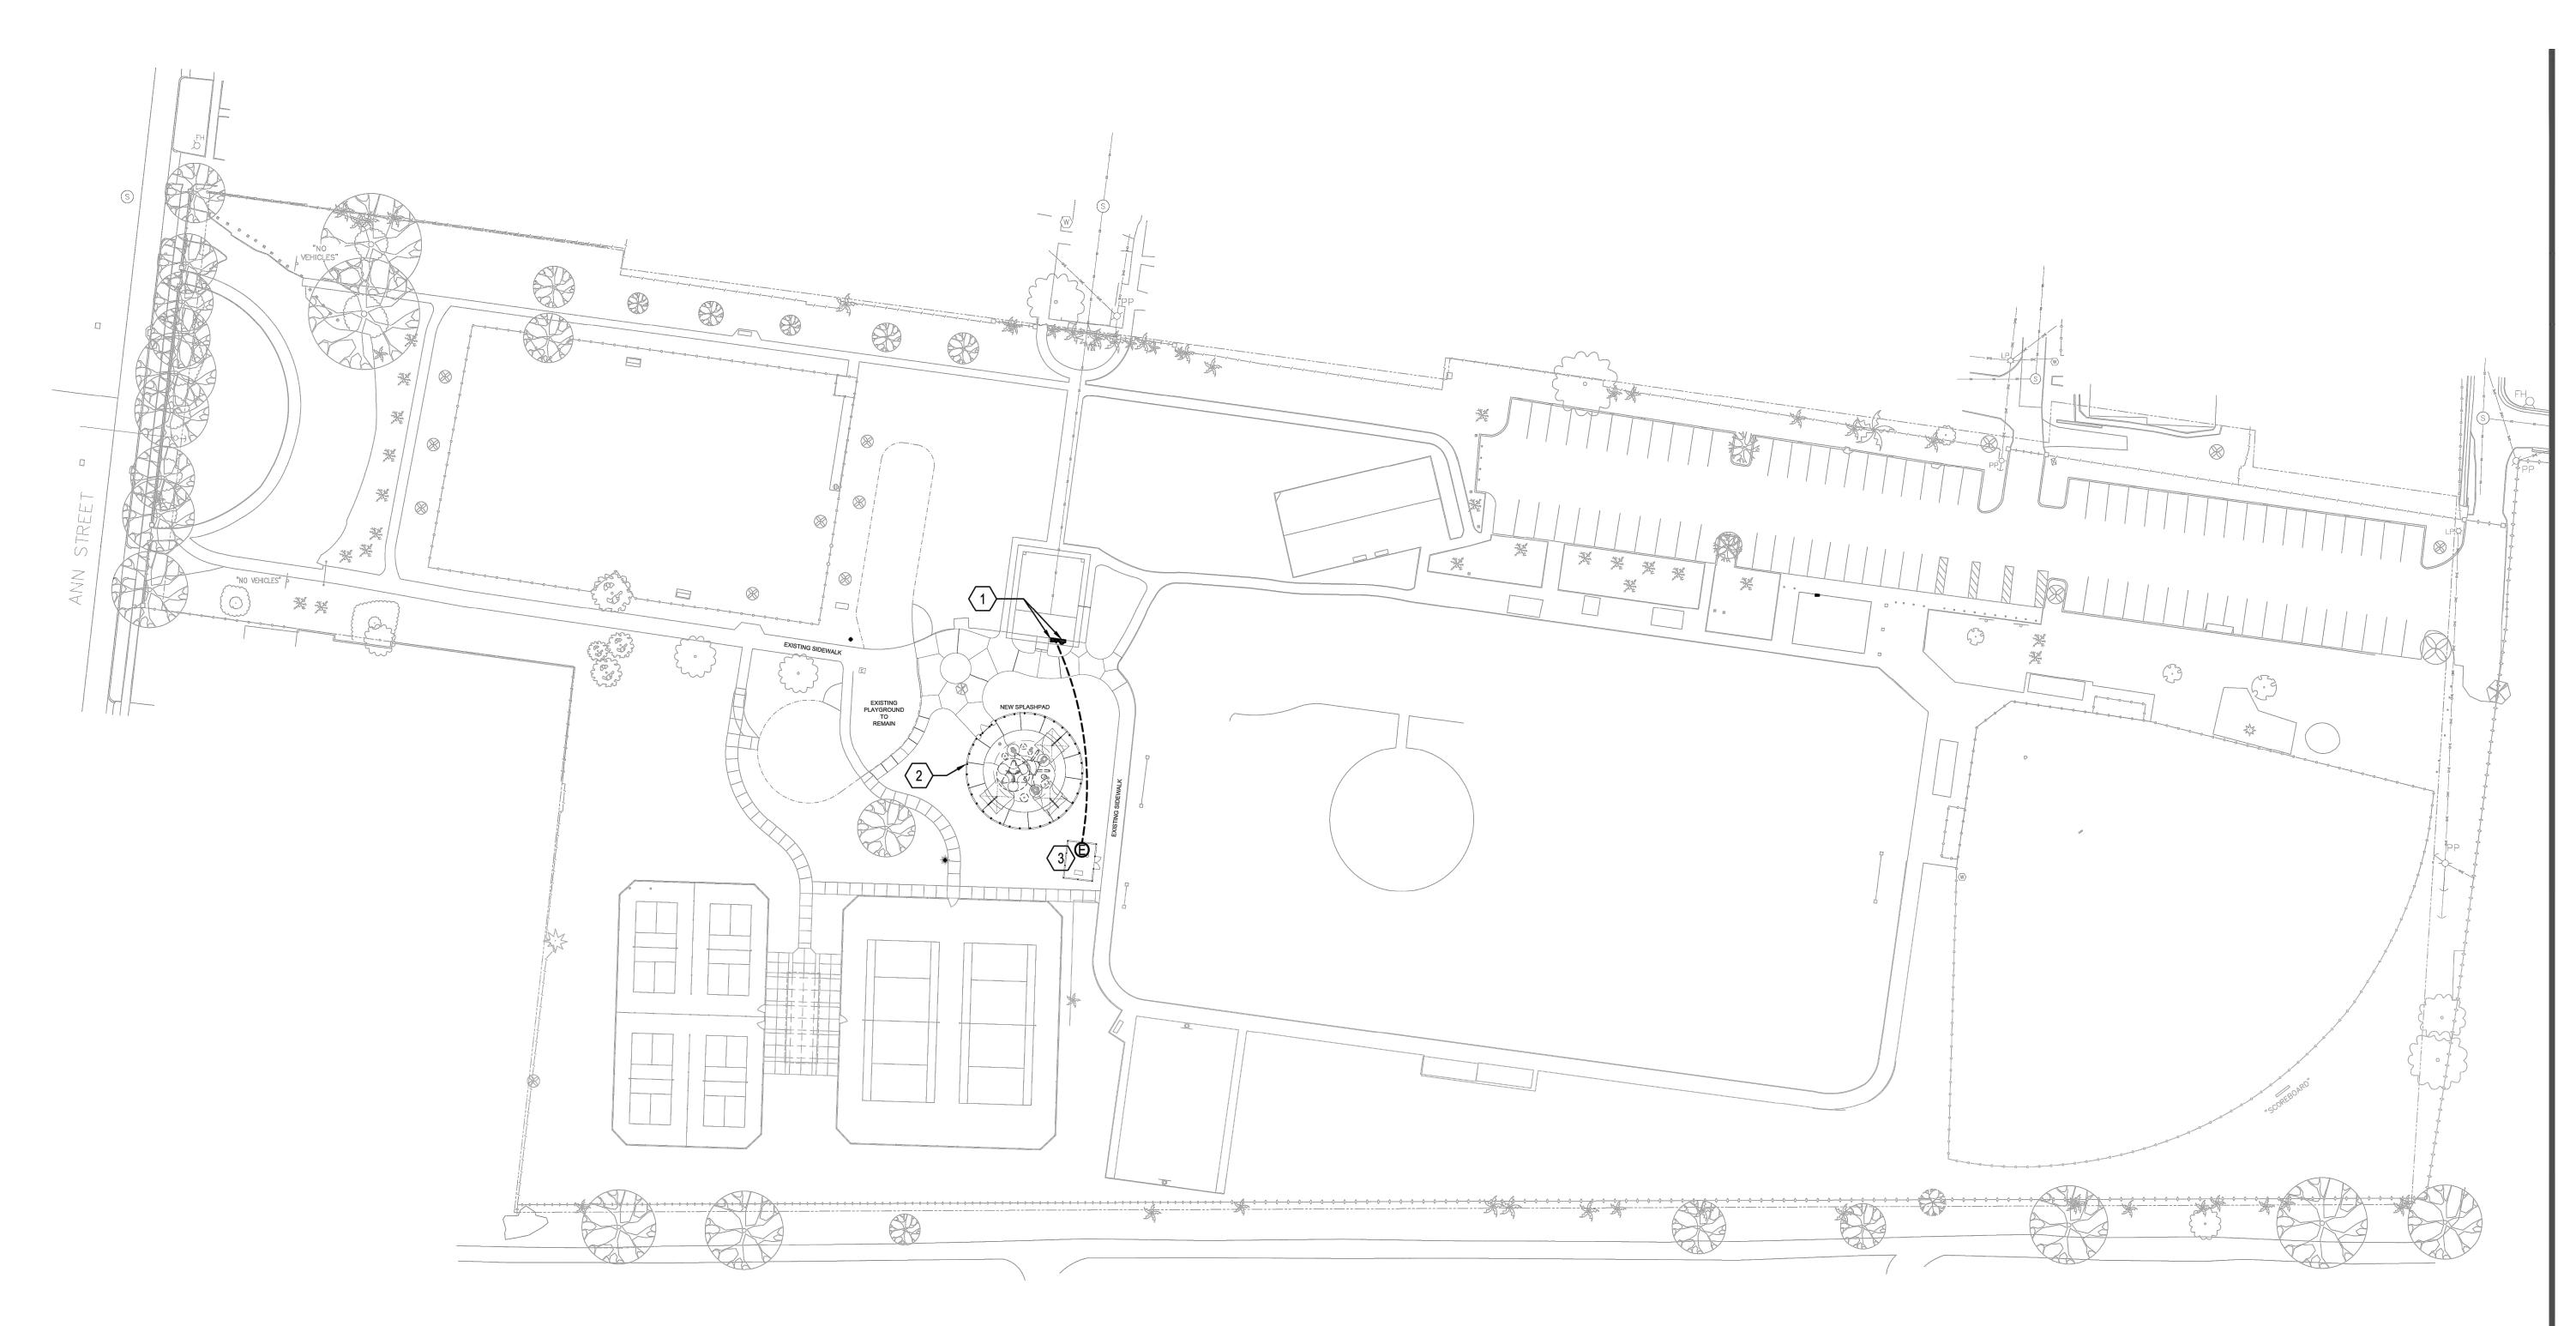
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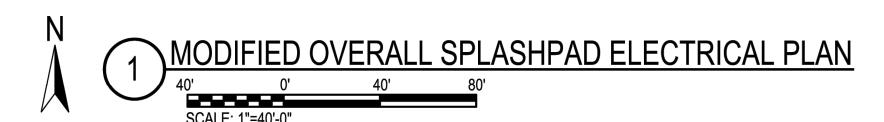
EXISTING OVERALL ELECTRICAL PLAN (BASE BID)



- 1 APPROXIMATE LOCATION OF EXISTING 240 VOLT 125A 1Ø SERVICE TO REMAIN. MODIFY PER NEW WORK PLANS.
- 2 APPROXIMATE LOCATION OF NEW SPLASHPAD. SEE ENLARGED PLAN FOR MORE INFORMATION.
- 3 APPROXIMATE LOCATION OF NEW SPLASHPAD EQUIPMENT YARD. SEE ENLARGED PLAN FOR MORE INFORMATION.

GENERAL NOTE(S)

1. IT IS THE RESPONSIBILITY OF THE CONTRACTOR TO LOCATE ALL UNDERGROUND UTILITIES. NEW CONDUITS INSTALLED ARE TO BE INSTALLED TO AVOID CONFLICT WITH EXISTING TREE ROOT SYSTEMS AS WELL AS EXISTING UTILITIES. ALL NEW UNDERGROUND CONDUITS ARE TO BE INSTALLED A MINIMUM OF 24" BELOW FINISHED GRADE.





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King Lot
Lighting

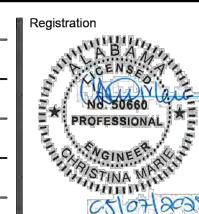
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05.16.25 ADDENDUM 1

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CM
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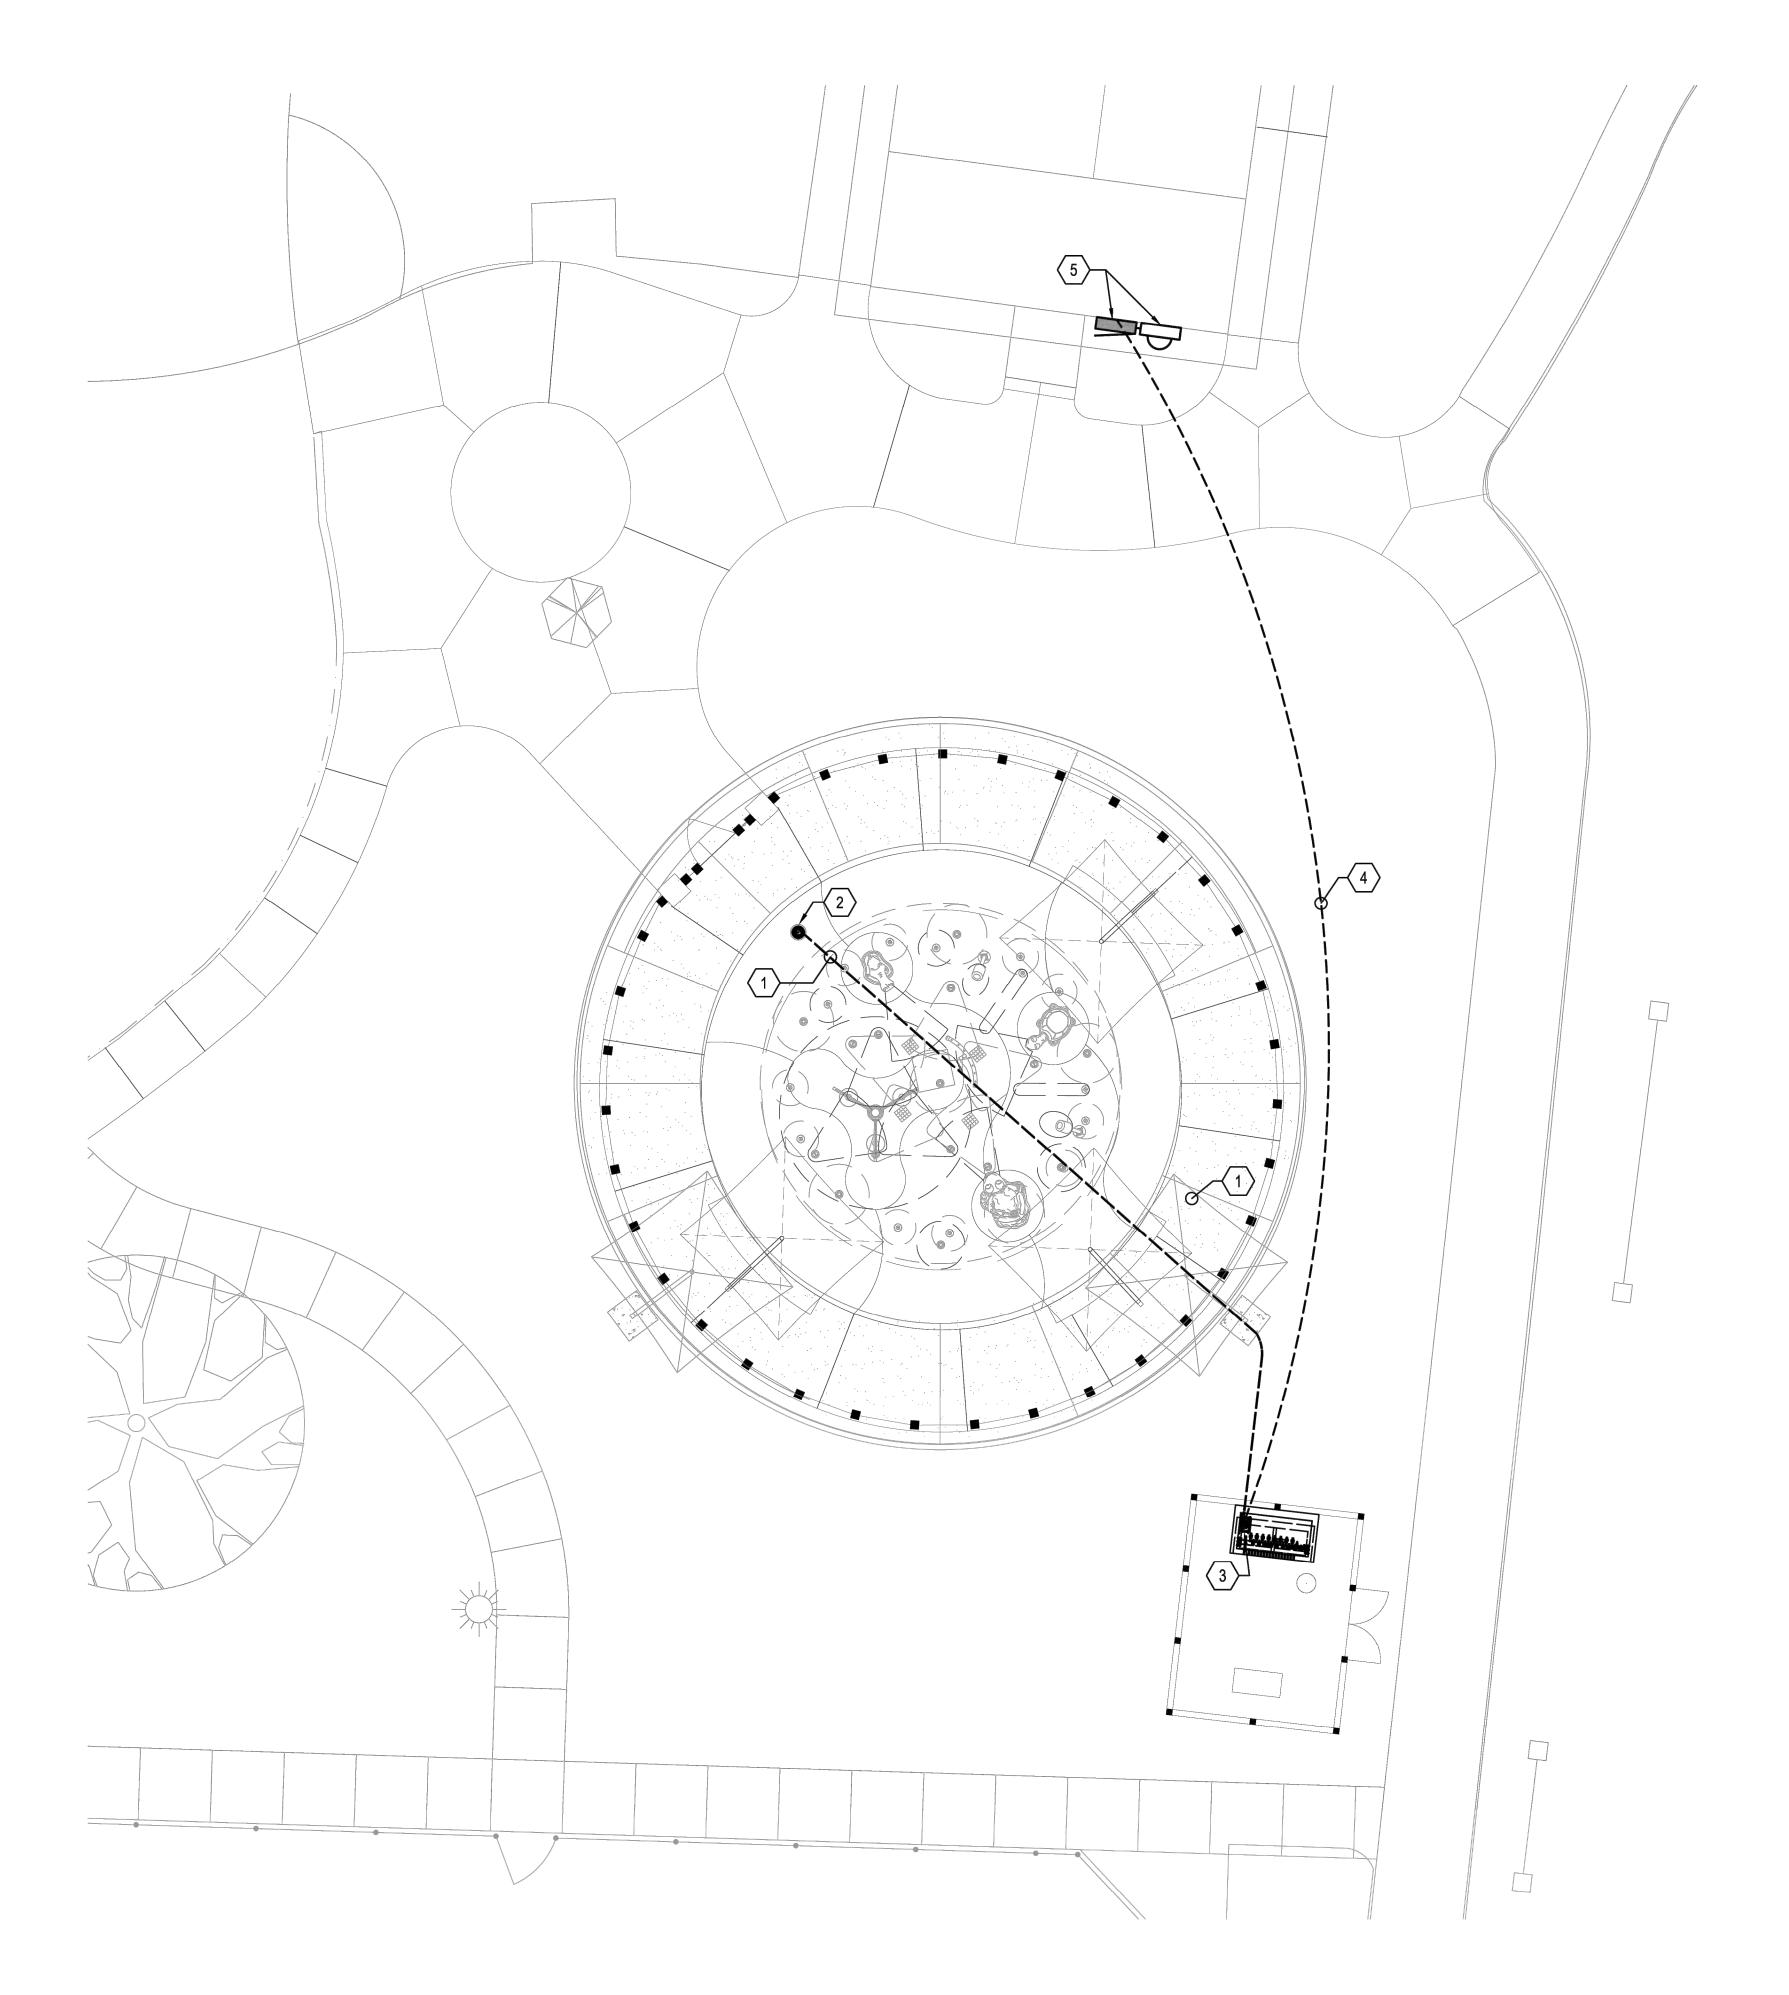
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Project No.



Sheet Title

MODIFIED OVERALL ELECTRICAL PLAN (BASE BID)

Sheet No. EP300



GENERAL NOTES

- 1. THE SPLASHPAD EQUIPMENT LAYOUT SHOWN IS BASED ON PRELIMINARY DESIGNS. THE ELECTRICAL CONTRACTOR SHALL COORDINATE THE FINAL LOCATION OF ALL SPLASHPAD EQUIPMENT WITH THE SPLASH PAD PROVIDER / INSTALLER PRIOR TO ROUGH IN. FIELD COORDINATE FINAL ROUTING OF CONDUIT TO AVOID CONFLICT.
- 2. THE ELECTRICAL CONTRACTOR SHALL COORDINATE THE POWER REQUIREMENTS OF ALL SPLASHPAD EQUIPMENT WITH THE SPLASH PAD PROVIDER / INSTALLER AND ADJUST ACCORDINGLY PRIOR TO BEGINNING ANY WORK TO ATTAIN A FULLY OPERATIONAL SYSTEM.

SHEET NOTES

- THE ELECTRICAL CONTRACTOR SHALL PROVIDE AND INSTALL 1" CONDUIT WITH PULL STRING FROM BOLLARD ACTIVATOR TO RAIN MAKER (CONDUIT SUPPLIED BY ELECTRICAL CONTRACTOR, CABLE SUPPLIED BY RAIN DROP PRODUCTS THE ELECTRICAL CONTRACTOR SHALL COORDINATE THE FINAL ROUTING OF THE CONDUIT WITH THE SPLASH PAD PROVIDER / INSTALLER PRIOR TO ROUGH IN.
- 2 APPROXIMATE LOCATION OF BOLLARD TOUCH SENSOR. FIELD COORDINATE FINAL LOCATION AND QUANTITY WITH EQUIPMENT PROVIDER / INSTALLER PRIOR TO ROUGH IN.
- FINAL LOCATION OF NEW SPLASHPAD CONTROLLER TO BE FIELD COORDINATED WITH EQUIPMENT PROVIDER / INSTALLER PRIOR TO BEGINNING ANY SPLASHPAD WORK. .
- THE CONTRACTOR SHALL BORE FROM THE EXISTING 125A MCB PANEL TO THE NEW SPLASHPAD CONTROL UNIT. THE ELECTRICAL CONTRACTOR IS TO PROVIDE AND INSTALL 2#8, 1#10G, 1" CONDUIT TO SERVE THE NEW CONTROL UNIT FOR THE NEW SPLASHPAD. THE CONDUIT SHALL BE PVC BELOW GRADE AND GRS ABOVE GRADE. THE TRANSITION FROM PVC TO GRS SHALL OCCUR BELOW GRADE. THE ELECTRICAL CONTRACTOR SHALL COORDINATE FINAL ROUTE PRIOR TO BEGINNING ANY WORK TO AVOID CONFLICT WITH EXISTING TREE ROOT SYSTEM.
- APPROXIMATE LOCATION OF EXISTING 240 VOLT 125A 1Ø SERVICE TO REMAIN. MODIFY PER NEW WORK PLANS. EXISTING PANEL SCHEDULE IS LOOSELY STUCK IN THE PANEL FRAME THE ELECTRICAL CONTRACTOR IS TO PROVIDE AN UPDATED TYPE WRITTEN PANEL SCHEDULE IN CLEAR SLEEVE ATTACHED ON INSIDE OF DOOR.



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d-Murphy Park: ad, Parking Lot & Lighting

 Date
 Revisions / Submissions

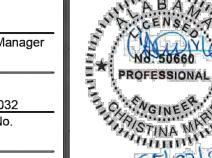
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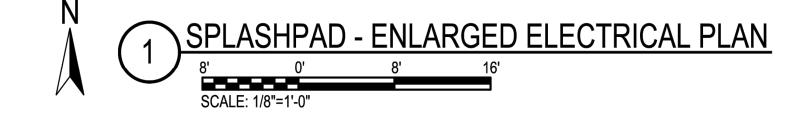


Sheet Title

SPLASHPAD ENLARGED
ELECTRICAL PLAN
(BASE BID)

Sheet N





			PA	NEL	BOAF	RD S	CHE	DULE	=		
	MARK: EXISTING PANEL 2P1 - SI	ERVIC									
CKT	LOAD	BRI	EAKER	PHASI	E (kVA)	PHASE	(kVA)	BREAKE	R	LOAD	СКТ
#	DESCRIPTION	Р	TRIP	Α	В	Α	В	TRIP	Р	DESCRIPTION	#
1	EXISTING BATHROOM	1	20					15	1	EXISTING BATH LIGHTS	2
3	EXISTING PAVILION	1	20					20	1	EXISTING BATH RECEPTACLES	4
5	EXISTING EXTERIOR LIGHTS	1	20					20	1	EXISTING PAVILION LIGHTS	6
7	EXISTING POLE LIGHTS	2	20					20	1	EXISTING PAVILION RECEPTACLES	8
9								20	1	MUSCO CONTROL	10
11	EXISTING POLE LIGHTS	2	20					20	1	SPARE	12
13								20	2	PICKLEBALL COURT LIGHTING	14
15	EXISTING POWER	1	20							MUSCO	16
17	EXISTING POWER	1	20					20	2	PICKLEBALL COURT LIGHTING	18
19	SPACE									MUSCO	20
21	SPACE							20	2	PICKLEBALL COURT LIGHTING	22
23	SPACE									MUSCO	24
	TOTAL (kV	٠.		ØB	AD (kVA)	-		HIGH PH		`	
CRE/	ATE A DIRECTORY TO INDICATE INSTALI				` '		G, AHU-			M NUMBERS FOR EVERY BRANCH CIRCL	UIT.

	MARK: MODIFIED PANEL 2P1 - SE	RVIC	E ENTRA	NCE RAT	ED						
CKT	LOAD	BRI	EAKER	PHASI	E (kVA)	PHASE	E (kVA)	BREAKE	R	LOAD	СКТ
#	DESCRIPTION	Р	TRIP	Α	В	Α	В	TRIP	Р	DESCRIPTION	#
1	EXISTING BATHROOM	1	20					15	1	EXISTING BATH LIGHTS	2
3	EXISTING PAVILION	1	20					20	1	EXISTING BATH RECEPTACLES	4
5	EXISTING EXTERIOR LIGHTS	1	20					20	1	EXISTING PAVILION LIGHTS	6
7	EXISTING POLE LIGHTS	2	20					20	1	EXISTING PAVILION RECEPTACLES	8
9								20	1	MUSCO CONTROL	10
11	EXISTING POLE LIGHTS	2	20					20	1	NEW SITE LIGHTING	12
13								20	2	PICKLEBALL COURT LIGHTING	14
15	EXISTING POWER	1	20							MUSCO	16
17	EXISTING POWER	1	20					20	2	PICKLEBALL COURT LIGHTING	18
19	NEW SPLASHPAD CONTROLLER *	1	20							MUSCO	20
21	SPACE							20	2	PICKLEBALL COURT LIGHTING	22
23	SPACE									MUSCO	24

TOTAL CONNECTED LOAD (kVA) TOTAL LOAD (AMPS) CREATE A DIRECTORY TO INDICATE INSTALLED LOADS. INDICATE LOAD TYPE (REC, LTG, AHU-1, ETC.) & ROOM NUMBERS FOR EVERY BRANCH CIRCUIT.

* PROVIDE THIS CIRCUIT WITH A GFCI BREAKER



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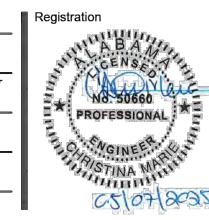
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Park: Crawford-Murphy

No.	<u>Date</u>	Revisions / Submissions
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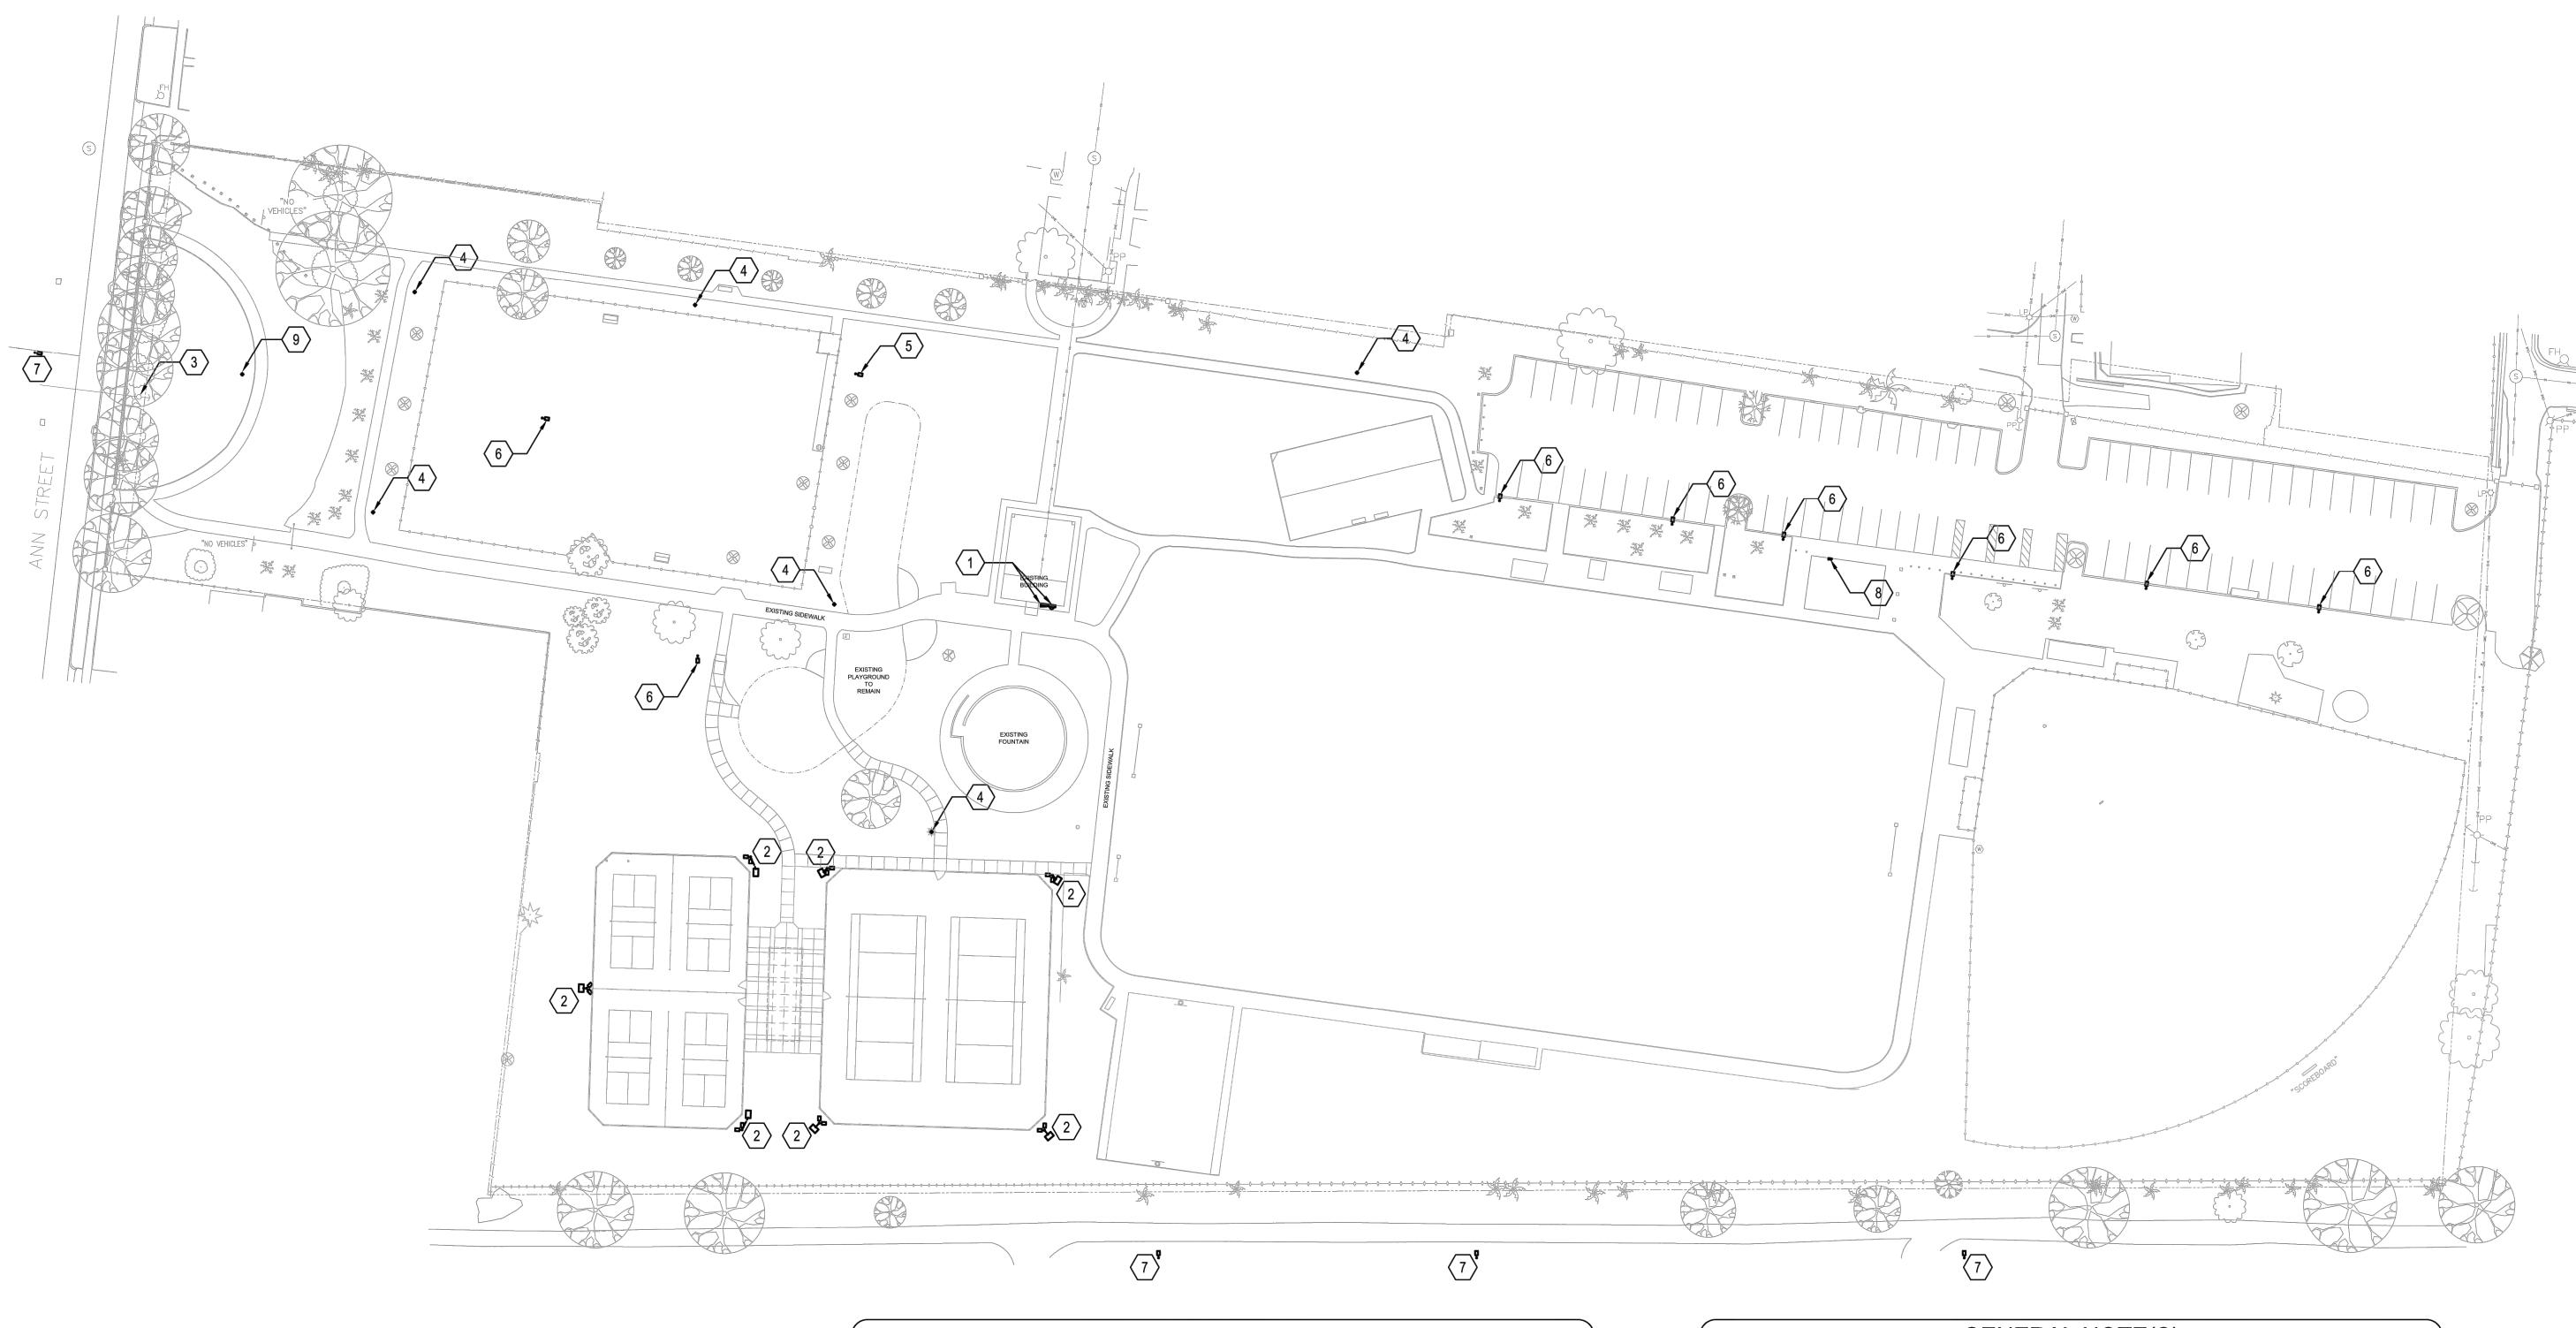
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Project Manager Principal



ELECTRICAL DETAILS AND SCHEDULES (BASE BID)

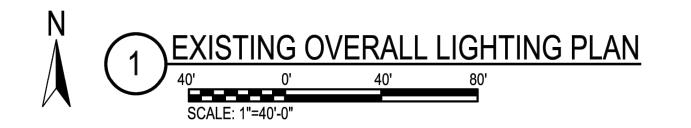




- 1 APPROXIMATE LOCATION OF EXISTING 240 VOLT 125A 1Ø SERVICE TO REMAIN. MODIFY PER NEW WORK PLANS.
- 2 APPROXIMATE LOCATION OF EXISTING MUSCO LIGHTING TO REMAIN.
- 3 APPROXIMATE LOCATION OF EXISTING RISER POLE TO REMAIN (NO LIGHT FIXTURE).
- 4 APPROXIMATE LOCATION OF EXISTING ACORN TYPE LIGHT POLE / FIXTURE TO REMAIN.
- APPROXIMATE LOCATION OF EXISTING WOOD POLE AND ASSOCIATED LIGHT FIXTURE TO BE REMOVED AND REPLACED NEW PER NEW WORK PLANS. EXISITING CIRCUIT TO BE SECURED FOR CONNECTION TO NEW FIXTURE.
- 6 APPROXIMATE LOCATION OF EXISTING PARKING LOT POLE AND ASSOCIATED LIGHT FIXTURE AND CONDUCTORS TO BE REMOVED AND REPLACED NEW PER NEW WORK PLANS.
- $\overline{7}$ APPROXIMATE LOCATION OF EXISTING STREET LIGHT POLE / FIXTURE TO REMAIN.
- $\langle 8 \rangle$ APPROXIMATE LOCATION OF EXISITNG RESTROOM BUILDING PANEL TO REMAIN. THE EXISTING PARKING LOT POLES ARE FED FROM AN EXISTING 20/2 BREAKER IN THIS PANEL. THE EXISITNG 20A 2-POLE BREAKER IS TO BE REMOVED AND REPLACED WITH (2) 20/1 (10KAIC) BREAKERS. ONE TO SERVE THE NEW PARKING LOT LIGHTING AND ONE WILL BE MARKED AS SPARE. EXISITNG LIGHTING CONTROLS (TIMER, CONTRACTORS, ETC.) AND ASSOCIATED CONDUCTORS ARE TO BE COMPLETELY REMOVED (NEW FIXTURES TO HAVE INTEGRAL CONTROLS). ALL UNUSED AND ABANDONED CONDUIT AND CONDUCTORS ARE TO BE COMPLETELY REMOVED.
- 9 APPROXIMATE LOCATION OF ABANDONED FEEDER (CONDUIT AND CONDUCTORS). EXISITNG ABANDONED CONDUCTORS TO BE REMOVED AND NEW HANDHOLD INSTALLED PER NE WORK PLANS.

GENERAL NOTE(S)

1. IT IS THE RESPONSIBILITY OF THE CONTRACTOR TO LOCATE ALL UNDERGROUND UTILITIES. NEW CONDUITS INSTALLED ARE TO BE INSTALLED TO AVOID CONFLICT WITH EXISTING TREE ROOT SYSTEMS AS WELL AS EXISTING UTILITIES. ALL NEW UNDERGROUND CONDUITS ARE TO BE INSTALLED A MINIMUM OF 24" BELOW FINISHED GRADE.





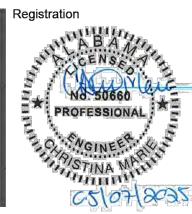
consulting MEP Engineering Christina Marie 50660 Alabama Certificate #CA-4146-E 813 Downtowner Blvd. Ste. D Mobile, Alabama 36609 P: 251-316-0015 F: 850-332-6629 DELL CONSULTING PROJECT: 23-127

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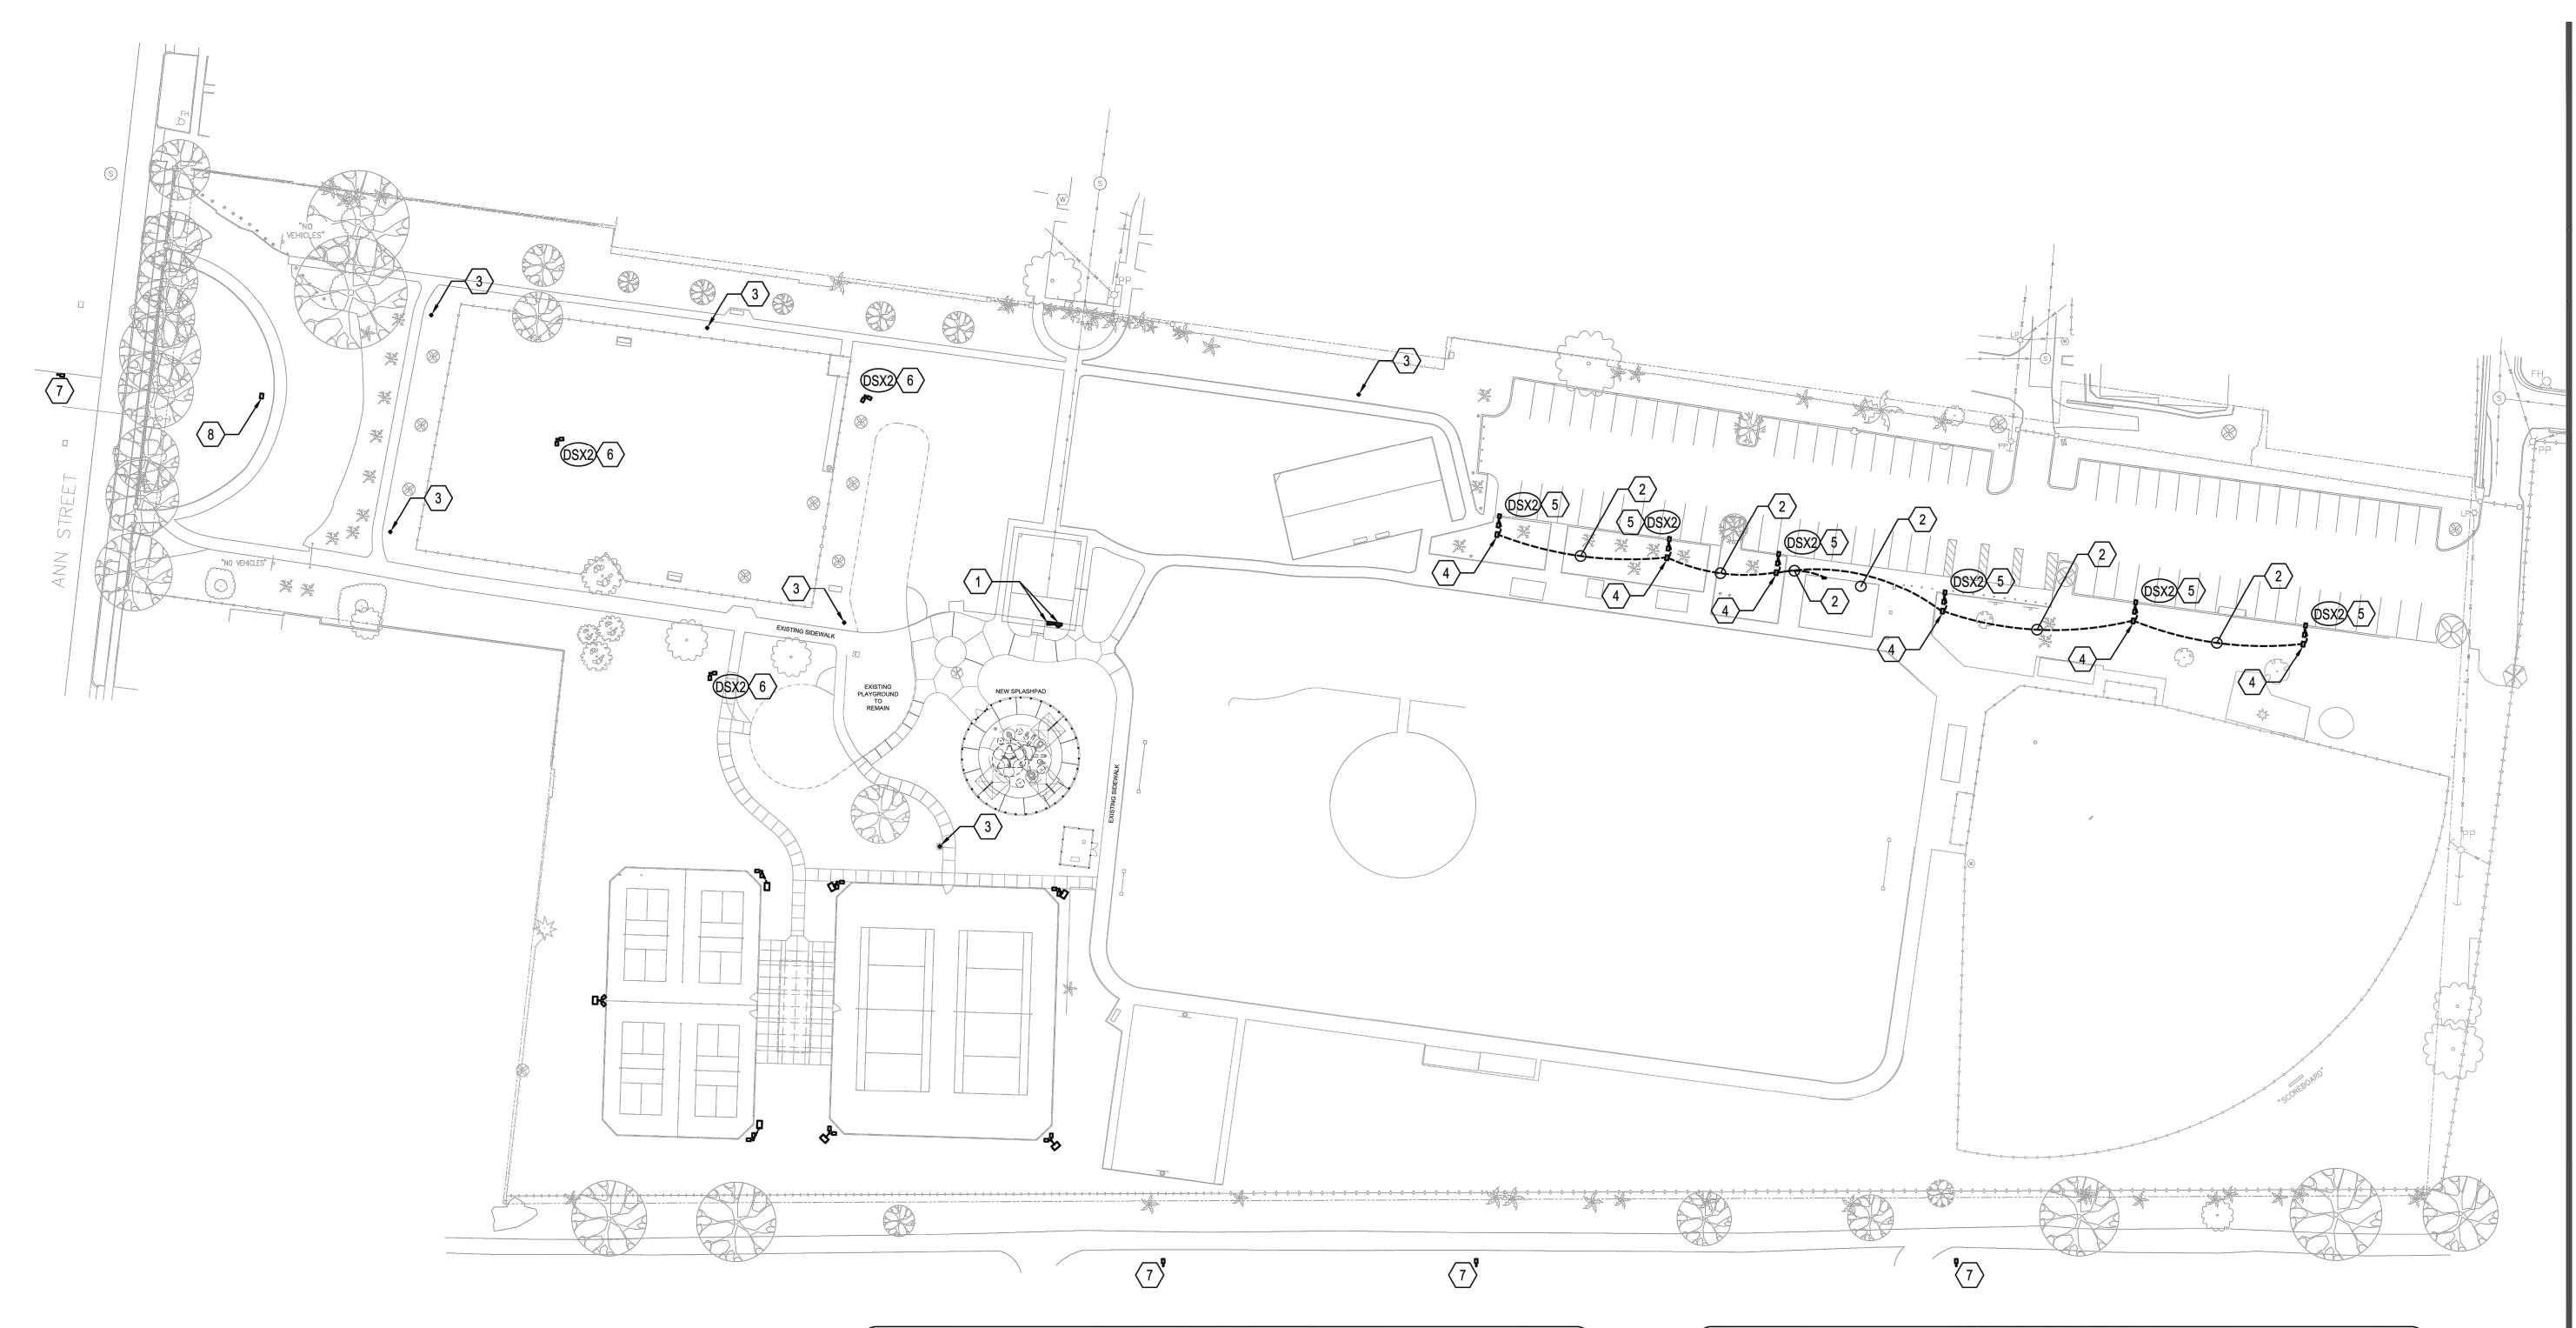
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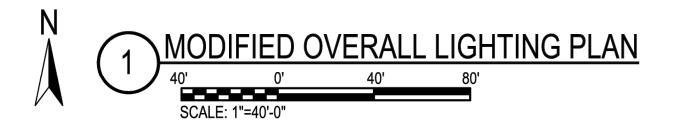
EXISTING OVERALL LIGHTING PLAN (ADD ALTERNATE 1)



- 1 APPROXIMATE LOCATION OF EXISTING 240 VOLT 125A 1Ø SERVICE TO REMAIN. MODIFY PER NEW WORK PLANS.
- THE ELECTRICAL CONTRACTOR SHALL PROVIDE AND INSTALL NEW 2#10, #10G IN 1" CONDUIT TO SERVE THE NEW PARKING LOT POLES. THE NEW POLES ARE TO BE FED FROM A NEW 20/1 (10KAIC) BREAKER IN EXISTING RESTROOM PANEL. EXISTING UNDERGROUND RACEWAYS ARE TO BE REUSED IF APPLICABLE AND IN GOOD CONDITION. NEW CONDUIT TO BE INSTALLED AS REQUIRED.
- 3 APPROXIMATE LOCATION OF EXISTING ACORN TYPE LIGHT POLE / FIXTURE TO REMAIN.
- THE ELECTRICAL CONTRACTOR SHALL PROVIDE AND INSTALL A NEW HANDHOLE AT THIS APPROXIMATE LOCATION TO SERVE NEW FIXTURES. SEE DETAIL FOR MORE INFORMATION, BOX LOCATION TO BE FIELD COORDINATE WITH EXISTING SERVE NEW FIXTURES. SEE DETAIL FOR MORE INFORMATION. BOX LOCATION TO BE FIELD COORDINATE WITH EXISITNG UNDERGROUND RACEWAY ROUTING.
- APPROXIMATE LOCATION OF NEW PARKING LOT POLE. ELECTRICAL CONTRACTOR TO REMOVE EXISTING CONDUCTORS AND REPLACE NEW FROM SERVING PANEL TO LIGHT FIXTURES USING EXISTING RACEWAYS. TWO FIXTURES AT 180°.
- 6 PROVIDE NEW POLE AND FIXTURE AT THIS LOCATION. CONNECT TO EXISTING CIRCUIT. TWO FIXTURES AT 90°.
- $\langle 7 \rangle$ APPROXIMATE LOCATION OF EXISTING STREET LIGHT POLE / FIXTURE TO REMAIN.
- 8 THE ELECTRICAL CONTRACTOR SHALL PROVIDE AND INSTALL A NEW HANDHOLE AT THIS APPROXIMATE LOCATION. THE EXISTING ABANDONED CONDUCTORS ARE TO BE COMPLETELY REMOVED AND THE CONDUIT IS TO BE CUT TO BELOW GRADE INSIDE THE HANDHOLE.

GENERAL NOTE(S)

1. IT IS THE RESPONSIBILITY OF THE CONTRACTOR TO LOCATE ALL UNDERGROUND UTILITIES. NEW CONDUITS INSTALLED ARE TO BE INSTALLED TO AVOID CONFLICT WITH EXISTING TREE ROOT SYSTEMS AS WELL AS EXISTING UTILITIES. ALL NEW UNDERGROUND CONDUITS ARE TO BE INSTALLED A MINIMUM OF 24" BELOW FINISHED GRADE.





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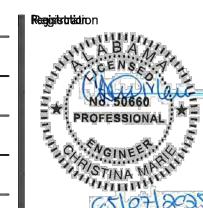
Revisions / Submissions 05.07.25 100% BID DRAWINGS 05.16.25 ADDENDUM 1

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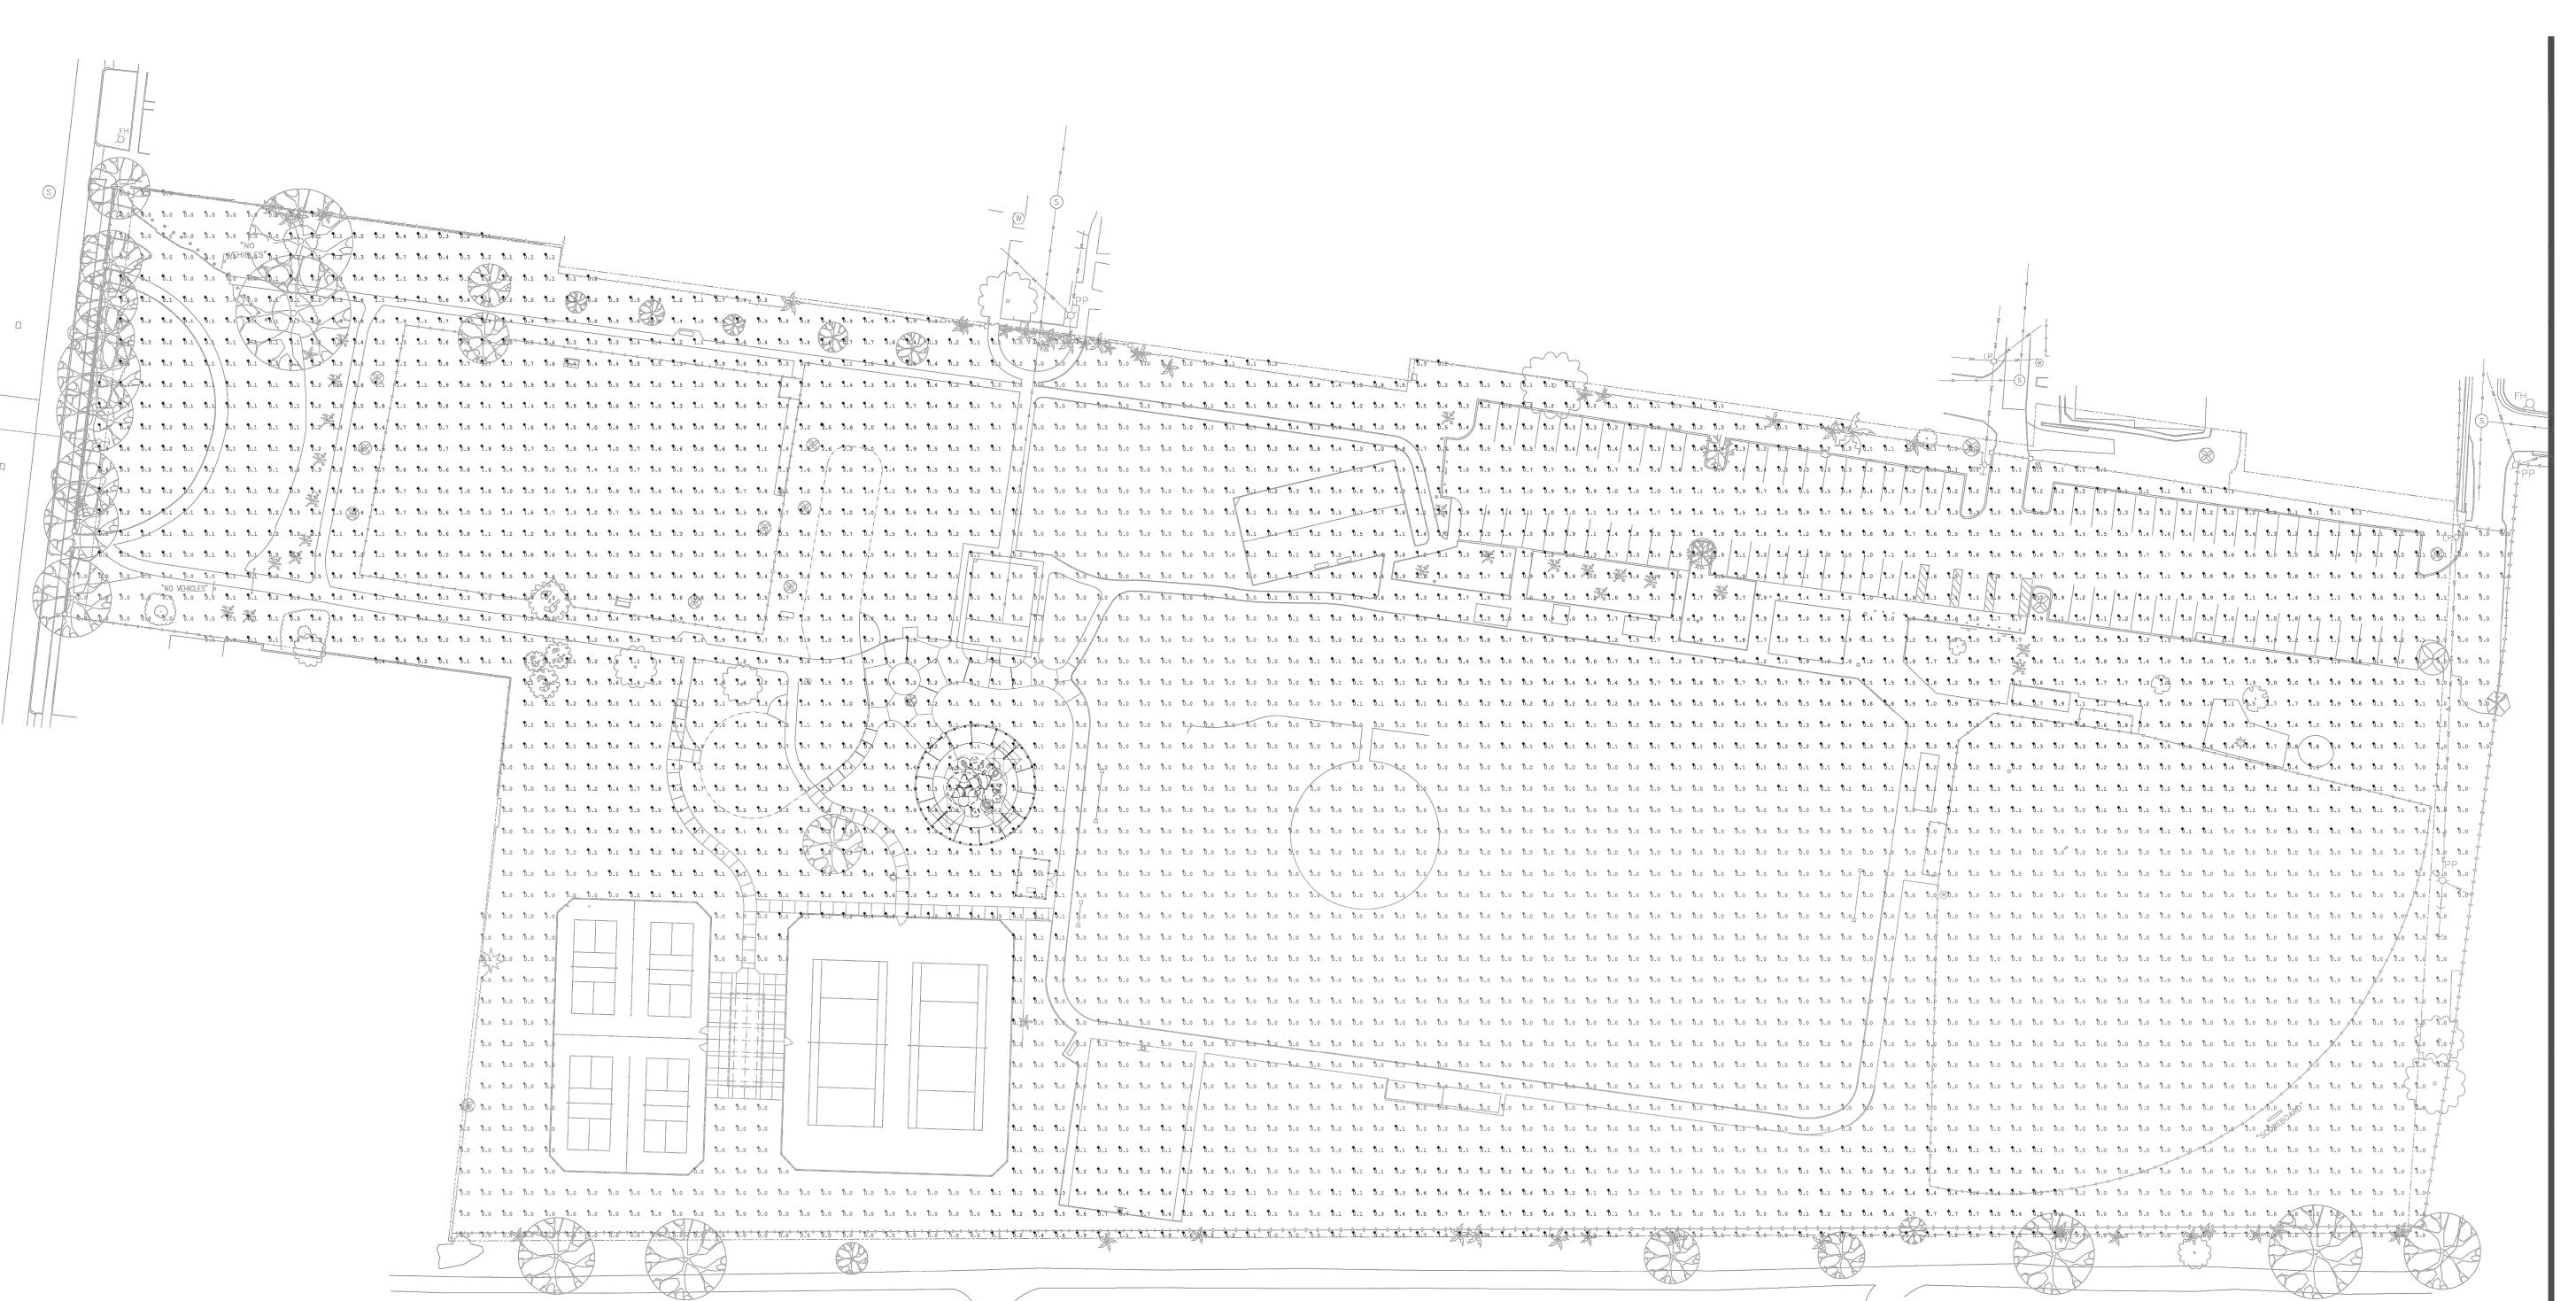
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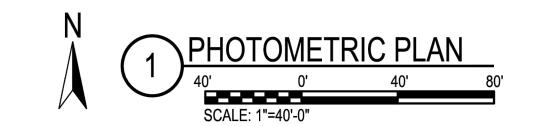


Sheet Title

MODIFIED OVERALL LIGHTING PLAN (ADD ALTERNATE 1)

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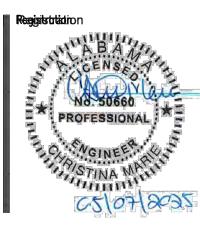
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PR-006-25; PR-007-23

No.	Date	Revisions / Submissions
	05.07.25	100% BID DRAWINGS
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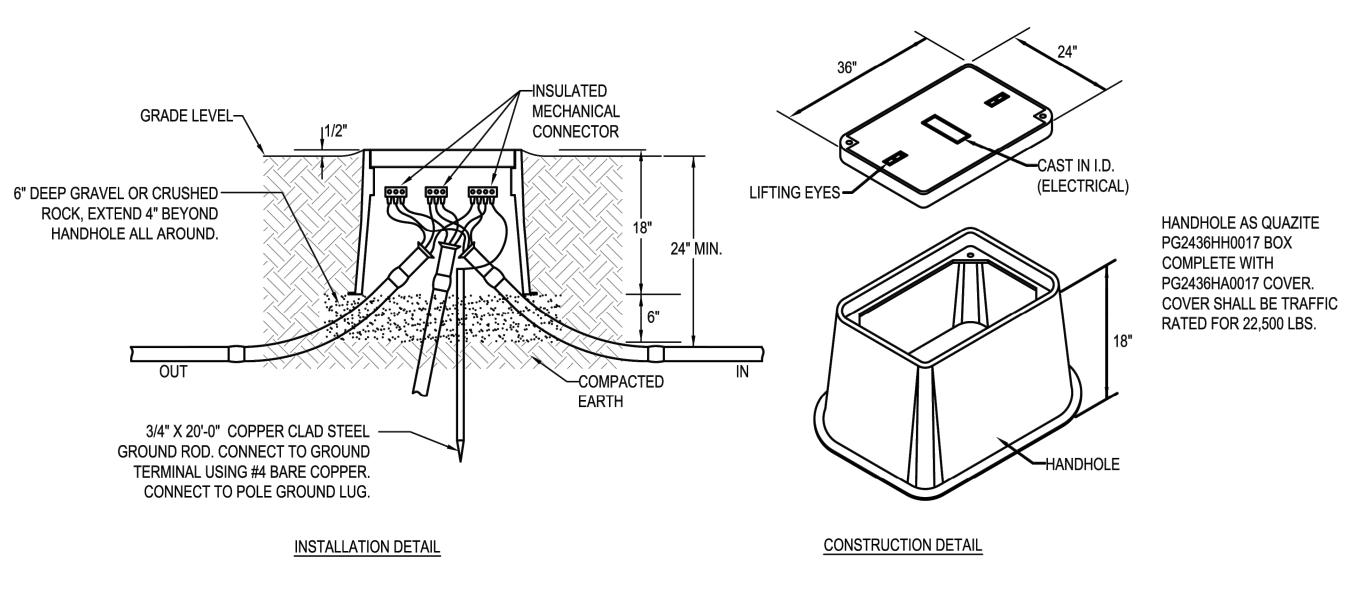


SITE PHOTOMETRIC
PLAN (ADD
ALTERNATE 1)

Sheet No.

(EL400)

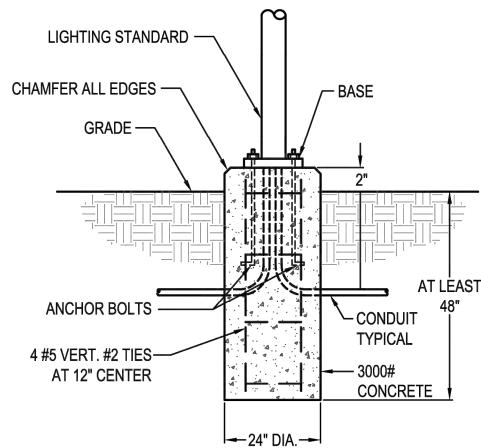
	LIGH	HTING	FIXTL	IRE SC	HEDULE	
MARK	MANUFACTURER AND CATALOG NUMBER	LAMPS	TOTAL	VOLTAGE	MOUNTING	NOTES
		TYPE	WATTS			
	LITHONIA LIGHTING					NEW POLES TO BE RATED FOR WINDS OF 150 MPH
DSX2	DSX0LED-P2-40K-70CRI-TFTM-MVOLT-RPA-PIR-DDBXD	LED	45	MVOLT	POLE	LED POLE MOUNTED SITE LIGHTING FIXTURE
	POLE - SSS-20-4C-DM19AS-TP-DDBXD				20' A.F.G.	WITH INTEGRAL MOTION AMBIENT SENSOR
NOTES	FIXTURES WITH HALF FILLED IN CENTER SHALL BE PROVIDE	ED WITH AN	EMERGENO	CY BALLAST,	1100 LUMENS OR	THE MAXIMUM AVAILABLE FOR THE FIXTURE.
	THE ELECTRICAL CONTRACTOR SHALL PROVIDE AND INSTA	ALL ALL MOU	JNTING HAF	DWARE AS F	REQUIRED FOR A C	COMPLETE INSTALLATION
	ALL FIXTURES TO BE APPROVED BY ARCHITECT / OWNER P	RIOR TO OR	RDER.			



HANDHOLE NOTES:

- 1. HANDHOLE SHALL HAVE LOGO CAST IN COVER (LOGO=ELECTRICAL). INSTALL IN ACCORDANCE WITH THE MANUFACTURER'S PRINTED INSTRUCTIONS AND THESE REQUIREMENTS.
- 2. TERMINATE CONDUITS ENTERING HANDHOLE WITH END BELL. CONSTRUCT CONDUIT RISE TO ENTER BOX FROM SIDE WITH 22-1/2° SWEEP ELBOWS.
- 3. CONDUITS ENTERING AND LEAVING HANDHOLE SHALL BE SEALED IN ACCORDANCE WITH THE NATIONAL ELECTRICAL CODE ARTICLES 514 AND 501.15.

\ELECTRICAL HANDHOLE DETAIL (BASE BID)



- 1. INSTALL A 5/8" BY 10'-0" COPPERCLAD STEEL GROUND ROD DRIVEN BESIDE EACH BASE AND PROVIDE A #6 COPPER BOND FROM GROUND ROD TO BASE OF POLE. PROVIDE ALL NECESSARY LUGS OR TERMINALS TO CONNECT TO POLE.
- 2. BASE TO BE POURED AGAINST UNDISTURBED EARTH. DO NOT PLACE ANY PORTION OF BASE BELOW WATER TABLE.
- 3. SEE PLANS FOR LOCATION AND QUANTITIES.





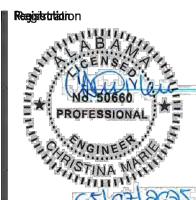
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placemaking

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ELECTRICAL DETAILS AND SCHEDULES (ADD ALTERNATE 1)

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